

PROJECT MANAGER S. KERN

CHECK S. KERN


DRAFTING F. CIUCCIO

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JOB MANAGER D. THOMAS

DESIGN SUPERVISOR J. SIMKULET



PROJECT LOCATION

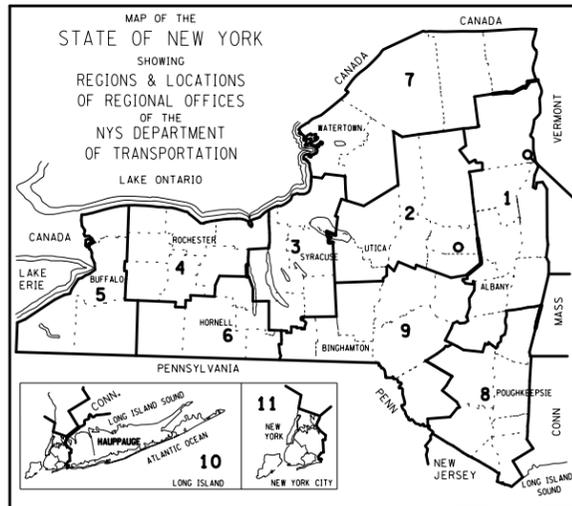

VETERAN'S ROAD CULVERT REPLACEMENT
OVER FIVE MILE CREEK

TOWN OF TICONDEROGA
ESSEX COUNTY
NEW YORK


APRIL 15, 2021

45 SHEETS

CONTRACT NO. D036296

TOWN OF TICONDEROGA

CONTRACTOR'S NAME	_____
AWARD DATE	_____
COMPLETION DATE	_____
FINAL ACCEPTANCE DATE	_____
ENGINEER IN CHARGE	_____
FINAL COST TOTAL	_____

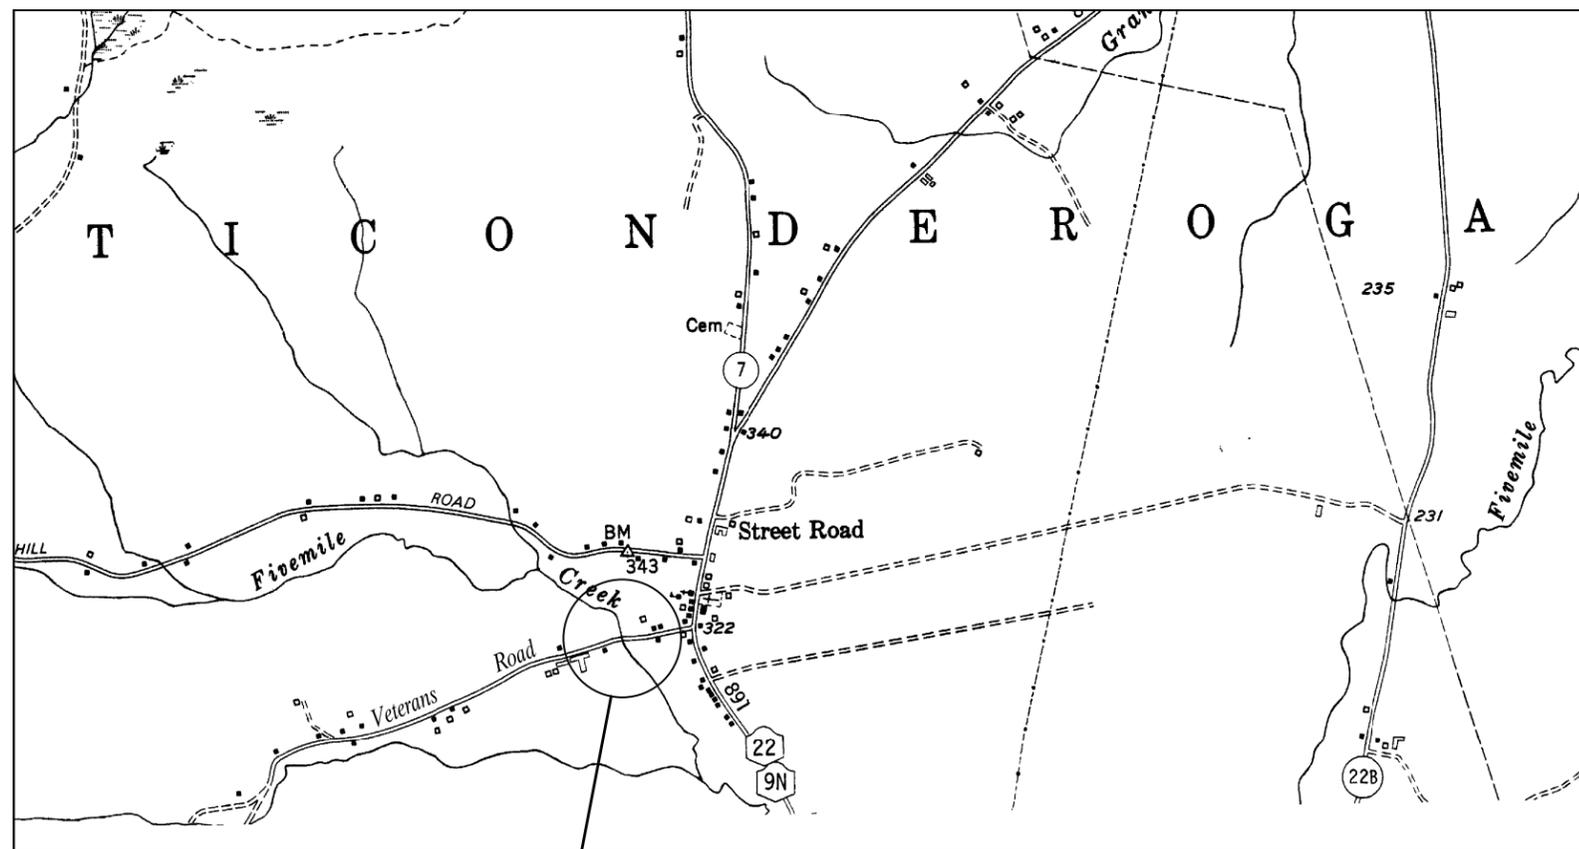

PROJECT LOCATION

PROJECT LOCATION
NOT TO SCALE

THE LATEST REVISIONS OF THE STANDARD SHEETS MAINTAINED BY THE DEPARTMENT, WHICH ARE CURRENT ON THE DATE OF ADVERTISEMENT FOR BIDS, SHALL BE CONSIDERED TO BE IN EFFECT. ALL PAY ITEMS AND WORK CONTAINED IN THE CONTRACT AND ANY ADDITIONAL PAY ITEMS AND WORK ENCOUNTERED DURING THE COURSE OF THE CONTRACT SHALL BE SUBJECT TO THE APPLICABLE STANDARD SHEET(S) UNLESS OTHERWISE SPECIFIED IN THE CONTRACT DOCUMENTS.

ALL WORK CONTEMPLATED UNDER THIS CONTRACT IS TO BE COVERED BY AND IN CONFORMITY WITH THE NYS DOT STANDARD SPECIFICATIONS (US CUSTOMARY) REFERENCED IN THE CONTRACT PROJECT "PROPOSAL" EXCEPT AS MODIFIED BY THESE PLANS OR BY CHANGES SET FORTH IN THE CONTRACT PROJECT "PROPOSAL".

CONTRACT PLANS HAVE BEEN DESIGNED IN ACCORDANCE WITH NYS DOT POLICIES AND GUIDELINES.

PREPARED AND RECOMMENDED BY:



Shert Kern
SHERT KERN, P.E.
PROJECT MANAGER/STRUCTURAL ENGINEER

John P. Simkulet
JOHN SIMKULET, P.E.
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GPI
GREENMAN-PEDERSEN, INC.
CONSULTING ENGINEERS

80 WOLF ROAD, SUITE 300
ALBANY, NY 12205

VETERAN'S ROAD CULVERT REPLACEMENT OVER FIVE MILE CREEK		
TOWN OF TICONDEROGA		
COUNTY: ESSEX		
FED. ROAD REG. NO.	STATE	SHEET NO.
1	N.Y.	1
CAPITAL PROJECT IDENTIFICATION NO. 1761.09		

INDEX ON SHEET NO. 2

APPROVED BY

Robert R. Leville
ROBERT LEVILLE, ASSISTANT CIVIL ENGINEER
ESSEX COUNTY DEPARTMENT OF PUBLIC WORKS

DATE

ALIGNMENT		TOPOGRAPHY (MISCELLANEOUS)		UTILITIES	
ABBR.	DESCRIPTION	ABBR.	DESCRIPTION	ABBR.	DESCRIPTION
AH	AHEAD	ABUT	ABUTMENT	E	ELECTRIC
AZ	AZIMUTH	AOBE	AS ORDERED BY ENGINEER	EMH	ELECTRIC MANHOLE
BK	BACK	ASPH	ASPHALT	G	GAS
B	BASELINE	BDY	BOUNDARY	GP	GUY POLE
BRG	BEARING	BLDG	BUILDING	GSB	GAS SERVICE BOX (HOUSE LINE)
C	CENTERLINE	BM	BENCH MARK	GV	GAS VALVE (MAIN LINE)
CS	CURVE TO SPIRAL	CC	CENTER TO CENTER	HYD	HYDRANT
e	SUPERELEVATION RATE (CROSS SLOPE)	CONC	CONCRETE	LP	LIGHT POLE
EQ	EQUALITY	CONST	CONSTRUCTION	LPG	LOW PRESSURE GAS
EXT	EXTERNAL	CR	COUNTY ROAD	PP	POWER POLE
HCL	HORIZONTAL CONTROL LINE	D	DEED DISTANCE	SA	SANITARY SEWER
HSD	HEADLIGHT SIGHT DISTANCE	DM	DIRECT MEASUREMENT	SMH	SANITARY MANHOLE
L	LENGTH OF CIRCULAR CURVE	DWY	DRIVEWAY	ST	STORM SEWER
LS	LENGTH OF SPIRAL	EP	EDGE OF PAVEMENT	T	TELEPHONE
LVC	LENGTH OF VERTICAL CURVE	ES	EDGE OF SHOULDER	TCB	TRAFFIC CONTROL BOX
E	CENTER CORRECTION OF VERTICAL CURVE	FEE	FEE ACQUISITION	TELBOX	TELEPHONE BOX
M	MAIN LINE	FEE WO/A	FEE ACQUISITION WITHOUT ACCESS	TEL P	TELEPHONE POLE
PC	POINT OF CURVATURE	FP	FENCE POST	TMH	TELEPHONE MANHOLE
PI	POINT OF INTERSECTION	FD	FOUNDATION	CTV	CABLE TELEVISION
POL	POINT ON LINE	FL	FENCE LINE	W	WATER
PSD	PASSING SIGHT DISTANCE	GAR	GARAGE	WSB	WATER SERVICE BOX (HOUSE LINE)
PT	POINT OF TANGENT	GR	GRAVEL	WV	WATER VALVE (MAIN LINE)
PVC	POINT OF VERTICAL CURVE	HO	HOUSE	SUBSURFACE EXPLORATION	
PVI	POINT OF VERTICAL INTERSECTION	HWY	HIGHWAY		
PVT	POINT OF VERTICAL TANGENT	IP	IRON PIN OR IRON PIPE	ABBR.	DESCRIPTION
R	RADIUS	MB	MAILBOX	REPLACE ABBREVIATION "AB" WITH:	
SC	SPIRAL TO CURVE	MON	MONUMENT	AH	HAND AUGER
SSD	STOPPING SIGHT DISTANCE	N&W	NAIL AND WASHER	CP	CONE PENETROMETER
ST	SPIRAL TO TANGENT	OG	ORIGINAL GROUND	DA	2 1/4 INCHES CASED DRILL HOLE
STA	STATION	O/H	OVERHEAD	DM	DRILLING MUD
T	TANGENT LENGTH	P	PARCEL	DN	4 INCHES CASED DRILL HOLE
TGL	THEORETICAL GRADE LINE	PAV'T	PAVEMENT	FH	HOLLOW FLIGHT AUGER
TS	TANGENT TO SPIRAL	PE	PERMANENT EASEMENT	PA	POWER AUGER
VC	VERTICAL CURVE	PED POLE	PEDESTRIAN POLE	PH	PROBE
TOPOGRAPHY (DRAINAGE)		P	PROPERTY LINE	PT	PERCOLATION TEST HOLE
		POR	PORCH	RP	1 INCH SAMPLER (RETRACTABLE PLUG)
ABBR.	DESCRIPTION	RR	RAILROAD	TO BE DEFINED AT THE TIME OF EXPLORATION	
BB	BOTTOM OF BANK (STREAM)	RTE	ROUTE	SP	SEISMIC POINT
BC	BOTTOM OF CURB	ROW	RIGHT OF WAY	TP	TEST PIT
BO	BOTTOM OF OPENING	RW	RETAINING WALL	ABBREVIATION "C" IN CATAGORIES: DA, DM, DN, AND FH WITH:	
CAP	CORRUGATED ALUMINUM PIPE	SH	STATE HIGHWAY	B	BRIDGE
CB	CATCH BASIN	SHLDR	SHOULDER	C	CUT
CIP	CAST IRON PIPE	SPK	SPIKE	D	DAM
C STRM	CENTERLINE OF STREAM	ST	STREET	F	FILL
CMP	CORRUGATED METAL PIPE	STK	STAKE	K	CULVERT
CP	CONCRETE PIPE	STY	STORY	W	WALL
CSP	CORRUGATED STEEL PIPE	SW	SIDEWALK	X	TO BE USED IF ONE OF THE ABOVE CANNOT BE DEFINED AT THE TIME THE EXPLORATION IS MADE
CULV	CULVERT	TE	TEMPORARY EASEMENT		
DIA	DIAMETER	TO	TEMPORARY OCCUPANCY		
DMH	DRAINAGE MANHOLE	U/G	UNDERGROUND		
DS	DRAINAGE STRUCTURE PIPE	WW	WING WALL		
D'XING	DITCH CROSSING				
EHW	EXTREME HIGH WATER				
EL	ELEVATION				
ELEV	ELEVATION				
ELW	EXTREME LOW WATER				
ES	END SECTION				
HW	HEADWALL				
INV	INVERT				
MH	MANHOLE				
MHW	MEAN HIGH WATER				
OHW	ORDINARY HIGH WATER				
OLW	ORDINARY LOW WATER				
RCP	REINFORCED CONCRETE PIPE				
SICPP	SMOOTH INTERIOR CORRUGATED POLYETHYLENE PIPE				
TB	TOP OF BANK (STREAM)				
TC	TOP OF CURB				
TG	TOP OF GRATE				
VCP	VITRIFIED CLAY PIPE				

STANDARD SYMBOL (PLANS)	ITEM PAYMENT UNIT: ESTIMATE OF QUANTITIES SHEET	EQUIVALENT NOMENCLATURE: (SPECS/PROPOSAL)
"	-	INCHES
'	LF	LINEAR FEET
mi	MI	MILES
ft ²	SF	SQUARE FEET
YD ²	SY	SQUARE YARD
AC	AC	ACRES
YD ³	CY	CUBIC YARD
GAL	GAL	GALLON
lb	LB	POUND
TON	TON	TON

AS-BUILT REVISIONS DESCRIPTION OF ALTERATIONS:	VETERAN'S ROAD CULVERT REPLACEMENT	PIN 1761.09	BRIDGES	CULVERTS	ALL DIMENSIONS IN ft UNLESS OTHERWISE NOTED	CONTRACT NUMBER D036296
	OVER FIVE MILE CREEK					
	TOWN OF TICONDEROGA				INDEX AND ABBREVIATIONS	DRAWING NO. IND-1 SHEET NO. 2
	COUNTY: ESSEX	REGION: 1				

IT IS A VIOLATION OF LAW FOR ANY PERSON, UNLESS THEY ARE ACTING UNDER THE DIRECTION OF A LICENSED PROFESSIONAL ENGINEER, ARCHITECT, LANDSCAPE ARCHITECT, OR LAND SURVEYOR, TO ALTER AN ITEM IN ANY WAY. IF AN ITEM BEARING THE STAMP OF A LICENSED PROFESSIONAL IS ALTERED, THE ALTERING ENGINEER, ARCHITECT, LANDSCAPE ARCHITECT, OR LAND SURVEYOR SHALL STAMP THE DOCUMENT AND INCLUDE THE NOTATION "ALTERED BY" FOLLOWED BY THEIR SIGNATURE, THE DATE OF SUCH ALTERATION, AND A SPECIFIC DESCRIPTION OF THE ALTERATION.

STANDARD SHEETS:
 203-01, 607-04, 607-06, 608-01, 608-03, 609-01, 609-02, 609-04, 619-01, 619-02, 619-10, 619-11, 619-12, 619-50, 619-62, 625-01, 663-01

INDEX		45 SHEETS	
SHEET NO.	DESCRIPTION	DRAWING NO.	
1	COVER		
2	INDEX AND ABBREVIATIONS	IND-1	
3	LEGEND (1 OF 2)	LEG-1	
4	LEGEND (2 OF 2)	LEG-2	
5	GENERAL NOTES (1 OF 2)	GNN-1	
6	GENERAL NOTES (2 OF 2)	GNN-2	
7	WORK ZONE TRAFFIC CONTROL GENERAL NOTES	WZT-1	
8	WORK ZONE TRAFFIC CONTROL PLAN - STAGE 1	WZT-2	
9	WORK ZONE TRAFFIC CONTROL TYPICAL SECTION - STAGE 1	WZT-3	
10	WORK ZONE TRAFFIC CONTROL PLAN - STAGE 2	WZT-4	
11	WORK ZONE TRAFFIC CONTROL TYPICAL SECTION - STAGE 2	WZT-5	
12	WORK ZONE TRAFFIC CONTROL SIGN TABLE	WZT-6	
13	EXISTING GENERAL PLAN	ST-1	
14	EXISTING BRIDGE PLAN	ST-2	
15	EXISTING TYPICAL SECTION	ST-3	
16	PROPOSED GENERAL PLAN	ST-4	
17	PROPOSED BRIDGE PLAN	ST-5	
18	PROPOSED TYPICAL SECTION	ST-6	
19	TYPICAL ROADWAY SECTIONS	ST-7	
20	PROPOSED PROFILE	ST-8	
21	SOLDIER PILE & LAGGING WALL DETAILS	ST-9	
22	STAGE 1 EXCAVATION PLAN	ST-10	
23	STAGE 1 BACKFILL PLAN	ST-11	
24	STAGE 2 EXCAVATION PLAN	ST-12	
25	STAGE 2 BACKFILL PLAN	ST-13	
26	EARTHWORK SECTIONS	ST-14	
27	PROPOSED BEGIN ABUTMENT	ST-15	
28	BEGIN ABUTMENT FOOTING REINFORCEMENT PLAN	ST-16	
29	PROPOSED END ABUTMENT	ST-17	
30	END ABUTMENT FOOTING REINFORCEMENT PLAN	ST-18	
31	PROPOSED WINGWALL ELEVATIONS	ST-19	
32	RIGHT WINGWALL REINFORCEMENT DETAILS	ST-20	
33	LEFT WINGWALL REINFORCEMENT DETAILS	ST-21	
34	THREE SIDED STRUCTURE FRAMING PLAN	ST-22	
35	MISCELLANEOUS DETAILS	ST-23	
36	WATER MAIN PLAN AND PROFILE	ST-24	
37	WATER MAIN DETAILS	ST-25	
38	PROPOSED RAILING PLAN	ST-26	
39	RAILING DETAILS (1 OF 3)	ST-27	
40	RAILING DETAILS (2 OF 3)	ST-28	
41	RAILING DETAILS (3 OF 3)	ST-29	
42	BAR BENDS	ST-30	
43	BAR LIST (1 OF 2)	ST-31	
44	BAR LIST (2 OF 2)	ST-32	
45	ESTIMATE OF QUANTITIES	EQQ-1	

ALIGNMENT			LANDSCAPE			ROADWAY			UTILITIES			
STYLE	NAME	DESCRIPTION	STYLE	NAME	DESCRIPTION	STYLE	NAME	DESCRIPTION	STYLE	NAME	DESCRIPTION	
	AC	CONTROL (CENTERLINE)		LABL	AREA, BRUSH LINE		RCZ_P	CLEAR ZONE		UC	CONDUIT, UNDERGROUND	
	AD_P	DETOUR		LAHR	AREA, HEDGE ROW		RG	GUIDE RAIL, MISCELLANEOUS		UCH	CONDUIT, HANGING	
	AT_P	TRANSITION CONTROL		LAPB	AREA, PLANTING BED		RGB	GUIDE RAIL, BOX BEAM		UCO	CONDUIT, OVERHEAD	
BRIDGE				LAWA	AREA, WOODED AREA OUTLINE		RGBM	GUIDE RAIL, BOX BEAM, MEDIAN		UE	ELECTRIC LINE, UNDERGROUND	
	BR	RAIL		LAWE	AREA, WATERS EDGE		RGC	GUIDE RAIL, CABLE		UEH	ELECTRIC LINE, HANGING	
	BSHT	SHEET PILING		LCUT_P	CUT LIMIT		RGCB	GUIDE RAIL, CONCRETE BARRIER		UEO	ELECTRIC LINE, OVERHEAD	
CONTROL				LFILL_P	FILL LIMIT		RGP_P	GUIDE POST		UETO	ELECTRIC TRANSMISSION, OVERHEAD	
	CB	BASELINE		LFNC	FENCE		RGW	GUIDE RAIL, W BEAM		UESS	ELECTRIC, SUBSTATIONS	
	CBPR	BASELINE, PROJECTION		LTRC	TREE ROW, CONIFEROUS		RGWM	GUIDE RAIL, W BEAM, MEDIAN		UFO	FIBER OPTIC, UNDERGROUND	
DRAINAGE				LTRD	TREE ROW, DECIDUOUS		RPB	PARKING BUMPER		UFOH	FIBER OPTIC, HANGING	
	DCP	CULVERT PIPE		LWH	WALL, H PILE		RRC	RAIL ROAD, CATENARY		UG	GAS, UNDERGROUND	
	DCP_P	CULVERT PIPE (DIR)		LWR	WALL, RETAINING		RRER	RAIL ROAD, 3RD RAIL		UGH	GAS, HANGING	
	DDG_P	DITCH, GRASS LINED		LWS	WALL, STONE		RRPLS_P	RAIL, PHOTO, LARGE SCALE		UGO	GAS, OVERHEAD	
	DDP_P	DITCH, PAVED INVERT	ROW MAPPING				RRPSS	RAIL, PHOTO, SMALL SCALE		UIC	INFORM CABLE, UNDERGROUND	
	DDS_P	DITCH, STONE LINED		MDL	DEED LINE		RRS	RUMBLE STRIP		UICH	INFORM CABLE, HANGING	
	DFL_P	FLOW LINE		MEE	EASEMENT, EXISTING		RRSLS_P	RAIL, SURVEY, LARGE SCALE		UO	OIL LINE, UNDERGROUND	
	DSSD	SLOTTED DRAIN		MEP_P	EASEMENT, PERMANENT		RRSSS	RAIL, SURVEY, SMALL SCALE		UOH	OIL LINE, HANGING	
	DUD_P	UNDERDRAIN		MEPA_P	EASEMENT, PERMANENT, APPROX.		SIGNS				UPBP	POLE, BRACE, PUSH BRACE
ENVIRONMENTAL				MET_P	EASEMENT, TEMPORARY		SBLB	BILLBOARDS		USA	SANITARY SEWER, UNDERGROUND	
	EBLHS	BALE, STRAW		META_P	EASEMENT, TEMPORARY, APPROX.		SM	MULTIPLE POST		USAH	SANITARY SEWER, HANGING	
	ECT	CURTAIN, TURBIDITY		MF_P	FEE ACQUISITION, W/ ACCESS		SSO	STRUCTURE, OVERHEAD		USAF	SANITARY SEWER, FORCE MAIN, UGND	
	EDMC	DAM, COFFER TYPE		MF_A_P	FEE ACQUISITION, APPROXIMATE		SSOC	STRUCTURE, OVHD. CANTILEVER		USAFH	SANITARY SEWER, FORCE MAIN, HANG	
	EDMEC_P	DAM, EARTHEN, CHECK		MFS_P	FEE ACQUISITION, SHAPE		STRIPING				UT	TELEPHONE, UNDERGROUND
	EDMPC_P	DAM, PREFAB, CHECK		MFWOA_P	FEE ACQUISITION, W/O ACCESS		STB*	BROKEN LINE		UTH	TELEPHONE, HANGING	
	EDMSC_P	DAM, STONE, CHECK		MHA	HISTORICAL, ACQUISITION		STDB*	DOUBLE BROKEN LINE		UTO	TELEPHONE, OVERHEAD	
	EFNS	FENCE, SILT		MHB	HIGHWAY BOUNDARY		STD*	DOTTED LINE LONG		UTV	CABLE TV, UNDERGROUND	
	EFNSV	FENCE, SILT & VEGETATION		MHBW	HWY BOUNDARY, FACE OF WALL		STDS*	DOTTED LINE SHORT		UTVH	CABLE TV, HANGING	
	EFNV	FENCE, VEGETATION		MHBWOA	HIGHWAY BOUNDARY, W/O ACCESS		STFB*	FULL BARRIER LINE		UTVO	CABLE TV, OVERHEAD	
	EWAA_P	WETLAND, ADJACENT AREA		MJC	JURISDICTION, CITY		STH*	HATCH LINE		UUU	UNKNOWN, UNDERGROUND	
	EFNS	FENCE, SILT		MJCY	JURISDICTION, COUNTY		STPB*	PARTIAL BARRIER LINE		UUH	UNKNOWN, HANGING	
	EFNSV	FENCE, SILT & VEGETATION		MJHD	JURISDICTION, HISTORIC DISTRICT		STRCT	ROUNDAABOUT, CAT TRACKS		UUO	UNKNOWN, OVERHEAD	
	EFNV	FENCE, VEGETATION		MJLL	JURIS., (GREAT, MILITARY) LOT LINE		STRYL	ROUNDAABOUT, YIELD LINE		UW	WATER LINE, UNDERGROUND	
	EWAA_P	WETLAND, ADJACENT AREA		MJN	JURISDICTION, NATION		STSB	STOP BAR		UWH	WATER LINE, HANGING	
	EWFS	WETLAND, FEDERAL AND STATE		MJPB	JURISDICTION, PUBLIC LANDS		STSE*	SOLID, EDGE		UWO	WATER LINE, OVERHEAD	
	EWFS	WETLAND, FEDERAL AND STATE		MJS	JURISDICTION, STATE		STXL*	X WALK, LADDER LINE				
	EWF	WETLAND, FEDERAL		MJT	JURISDICTION, TOWN							
	EWFS	WETLAND, FEDERAL AND STATE		MJV	JURISDICTION, VILLAGE							
	EWF	WETLAND, FEDERAL		MPL	PROPERTY LOT LINE							
	EWFS	WETLAND, FEDERAL AND STATE		MPLA	PROPERTY LOT LINE, APPROXIMATE							
	EWF	WETLAND, FEDERAL		MSL	SUB LOT LINE							
	EWFS	WETLAND, FEDERAL AND STATE										
	EWF	WETLAND, FEDERAL										
	EWFS	WETLAND, FEDERAL AND STATE										
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	EWFS	WETLAND, FEDERAL AND STATE										
	EWF	WETLAND, FEDERAL										
	EWFS	WETLAND, FEDERAL AND STATE										
	EWF	WETLAND, FEDERAL										

ALIGNMENT			DRAINAGE			ITS			ROW MAPPING			SIGNS			UTILITIES								
CELL	NAME	DESCRIPTION	CELL	NAME	DESCRIPTION	CELL	NAME	DESCRIPTION	CELL	NAME	DESCRIPTION	CELL	NAME	DESCRIPTION	CELL	NAME	DESCRIPTION						
⊗	ACC	CENTER OF CURVATURE	+	DINV	INVERT	⊕	IANT_P	ANTENNAS	⊕	MDL1P	DEED LINE, TYPE 1	⊕	S	SINGLE POST	⊕	UEB	ELECTRIC, BOX						
+	ACOGO	COGO	⊕	DS	STRUCTURE, RECTANGULAR	⊕	IASCTS	ACCOU. SPEED/COUNT SNSR.S	⊕	MDL2P	DEED LINE, TYPE 2	⊕	S.P	SINGLE POST, PROPOSED	⊕	UEM	ELECTRIC, METER						
⊙	ACS	CURVE TO SPIRAL	+	DSI	STRUCTURE, INVERT	⊕	ICABPAD	CABINET & PAD	⊕	MDL3P	DEED LINE, TYPE 3	⊕	SB.P	BACK TO BACK, PROPOSED	⊕	UEMH	ELECTRIC, MANHOLE						
△	ADPL_P	DETOUR, POINT OF INTERSECT.	⊕	DSM	STRUCTURE, MANHOLE	⊕	ICCTV	CCTV SITE	⊕	MDL4P	DEED LINE, TYPE 4	⊕	SDEL	DELINEATORS	⊕	UEPT	ELECTRIC, POLE, TRANS.						
○	ADPL_P	DETOUR, POINT ON LINE	⊕	DSMTXX_P	STRUCTURE, MANHOLE, TYPE "XX" "XX" = 48, 60, 72, 96	⊕	ICDPD	CDPD TRANSCEIVER	⊕	MDL5P	DEED LINE, TYPE 5	⊕	SPM	PARKING METER	⊕	UGM	GAS, METER						
○	AEQN	EQUATION	⊕	DSR	STRUCTURE, ROUND	⊕	ICELLT	CELL PHONE TOWER	⊕	MEEP	EASEMENT, EXISTING	⊕	SRM	REFERENCE MARKERS	⊕	UGMH	GAS, MANHOLE						
⊕	AEQNAHD	EQUATION AHEAD	⊕	DST"X"CB_P	STRUCTURE, RECT., WITH CURB TYPE "X" "X" = F, G, N, O, P, R	⊕	ICJB	CONDUIT JACK OR BORING	⊕	MEPAP_P	EASEMENT, PERM., APPROX.	⊕	SRSC3	SHLD, CTY, 123 DIG.	⊕	UGLM	GAS, LINE MARKER						
⊕	AEQNBK	EQUATION BACK	⊕	DST"X"CB_P	STRUCTURE, RECT., WITH CURB TYPE "X" "X" = F, G, N, O, P, R	⊕	ICNTLCAB	CONTROLLER CABINET	⊕	MEPP_P	EASEMENT, PERM., BACK LINE	⊕	SRSC4	SHLD, CTY, 4 DIG.	⊕	UGP	GAS/FUEL PUMP						
○	AEVT	EVENT STATION	⊕	DST"X"CB_P	STRUCTURE, RECT., WITH CURB TYPE "X" "X" = F, G, N, O, P, R	⊕	ICPB	COMMUNICATION PULL BOX	⊕	MEPSP_P	EASEMENT, PERM., SHAPE	⊕	SRSC2	SHLD, CTY TOUR, 1-2 DIG.	⊕	UGV	GAS, VALVE						
⊙	APC	POINT OF CURVATURE	⊕	DST"X"CB_P	STRUCTURE, RECT., WITH CURB TYPE "X" "X" = F, G, N, O, P, R	⊕	ICTD	CONDUIT TURNING DOWN	⊕	MFAP_P	FEE ACQUISITION, APPROX.	⊕	SRSC4	SHLD, CTY TOUR, 3-4 DIG.	⊕	UGVT	GAS, VENT						
○	APCC	POINT OF COMPOUND CURVATURE	⊕	DST"X"CB_P	STRUCTURE, RECT., WITH CURB TYPE "X" "X" = F, G, N, O, P, R	⊕	ICTU	CONDUIT TURNING UP	⊕	MFP_P	FEE ACQUISITION, BACK LINE	⊕	SRSI	SHLD, INTERSTATE	⊕	ULP	LIGHTING, POLE						
△	API	POINT OF INTERSECTION	ENVIRONMENTAL			⊕	ICVTRT	COMM. VEH. ROAD TRANSCEIVER	⊕	MFSP_P	FEE ACQUISITION, SHAPE	⊕	SRSN2	SHLD, NATIONAL, 2 DIG.	⊕	ULPM	LIGHTING, POLE, MEDIAN						
△	APOB	POINT OF BEGINNING				+	IDEFAULT	DEFAULT	⊕	MHBAP	HIGHWAY BNDRY., APPROX.	⊕	MHBCP	HISTORICAL, BLDG. CORNERS	⊕	SRSN3	SHLD, NATIONAL, 3 DIG.	⊕	ULPP	LIGHTING, POLE, PED.			
○	APOC	POINT OF CURVATURE	⊕	EIOP_P	STR., INLET, OUTLET PROT.	⊕	IEZR	E-ZPASS READER	⊕	MHBP	HIGHWAY BNDRY, PT.	⊕	SRSS2	SHLD, STATE, 2 DIG.	⊕	UMFC	MISC. FILLER CAP						
△	APOE	POINT OF END	⊕	EIPGB_P	STR., INLET PROT., GRAVEL BAG	⊕	IEZTR	TRANSMITTAL READER	⊕	MJCP	PT., JURIS. CITY	⊕	SRSS3	SHLD, STATE, 3 DIG.	⊕	UOLM	OIL, LINE MARKER						
○	APOL	POINT ON LINE	⊕	EIPHS_P	STR., INLET PROT., HAY/STRAW	⊕	IFXCAB	FIBER OPTIC X-CONNECT CABINET	⊕	MPBC	PT., BUILDING CORNER	⊕	SRSS4	SHLD, STATE, 4 DIG.	⊕	UP	POLE, WITH UTILITY						
○	APOS	POINT ON SPIRAL	⊕	EIPPS_P	STR., INLET PROT., HAY/STRAW	⊕	IFUSPL	FUSION SPLICE	⊕	MPCC	PT., CROSS CUT	TRAFFIC CONTROL			○	UPD	POLE, DEAD (NO UTILITY)						
○	APOT	POINT ON TANGENT	⊕	EIPPS_P	STR., INLET PROT., HAY/STRAW	⊕	IHARADV	HAR ADVISORY SIGN	⊕	MPDH	PT., DRILL HOLE				⊕	UPL	POLE, WITH LIGHT	⊕	USMH	SANITARY SEWER MANHOLE			
△	APOVC	POINT ON VERTICAL CURVE	⊕	EIPPS_P	STR., INLET PROT., HAY/STRAW	⊕	IHARST	HAR SITE	⊕	MPF	PT., FENCE LOCATION	⊕	TCBJ	BOX, JUNCTION	⊕	UTB	TELEPHONE, BOOTH						
△	APOVT	POINT ON VERTICAL TANGENT	⊕	EIPPS_P	STR., INLET PROT., HAY/STRAW	⊕	ILC	LOAD CENTER	⊕	MPIP	PT., IRON PIPE	⊕	TCBP	BOX, PULL BOX	⊕	UTLM	TELEPHONE, LINE MARKER						
Y	APORC	POINT ON REVERSE CURVE	⊕	ERCB	RISER, CONCRETE BOX	⊕	IMECSPL	MECHANICAL SPLICE	⊕	MPIR	PT., IRON ROD	⊕	TCBS	BOX, SPLICE	⊕	UTMH	TELEPHONE, MANHOLE						
⊙	APT	POINT OF TANGENCY	⊕	ETRS_P	TRAP, SEDIMENT	⊕	IMSCS	PORT. SPEED & COUNT SENSOR	⊕	MPM	PT., MONUMENT	⊕	TCMC	MICROCOMPUTER CABINET	⊕	UTVLM	CABLE TV, LINE MARKER						
⊙	APVC	POINT OF VERTICAL CURVATURE	⊕	EWFG	WETLAND FLAG	⊕	IMSCTS	MICRO SPEED & COUNT SENSOR	⊕	MPMM	PT., MONUMENT, MISC.	⊕	TCTP	PED POLE	⊕	UTVLM	CABLE TV, LINE MARKER						
△	APVCC	POINT OF VERT. CMPND CURVE	GEOTECHNICAL			⊕	IMT	MICROWAVE TRANSCEIVER	⊕	MPN	PT., NAIL	⊕	TCSH	SIGNAL HEADS	⊕	UTVPB	CABLE TV, PULL BOX						
⊕	APVI	POINT OF VERT. INTERSECTION				⊕	IOVHVS	PERM. OVERHEAD VMS	⊕	IPASCS	PORT. ACCOU. SPD & CNT. SENSOR	⊕	MPS	PT., SPIKE	⊕	TCSH	SIGNAL HEADS	⊕	UUB	UNKNOWN, BOX			
△	APVRC	POINT OF VERT. REVERSE CURVE	⊕	GDH	DRILL HOLE	⊕	IPEDS	PEDESTRIAN SIGNAL HEAD	⊕	MPS	PT., SPIKE	TRAFFIC WORK ZONE			⊕	UUB	UNKNOWN, BOX						
⊙	APVT	POINT OF VERTICAL TANGENCY	LANDSCAPE			⊕	IPSS	PAVEMENT SURFACE SENSOR	⊕	MPS	PT., SPIKE				⊕	TWZAP_P	ARROW PANEL	⊕	UUMH	UNKNOWN, MANHOLE			
⊙	ASC	SPIRAL TO CURVE				+	LELS	ELEVATION, SPOT	⊕	IPSS	PAVEMENT SURFACE SENSOR	⊕	MPST	PT., STAKE	⊕	TWZAP_P	ARROW PANEL, CAUTION MODE	⊕	UUPB	UNKNOWN, PULL BOX			
△	ASPI	SPIRAL POINT OF INTERSECTION	⊕	LFP	FLAG POLE	⊕	IPVMS	PERM. VMS	⊕	MPTW	PT., TREE W/ WIRE	⊕	TWZAPT_P	ARROW PANEL, TRAILER OR SUPPORT	⊕	UUVL	UNKNOWN, VALVE						
○	ASTS	SPIRAL TO SPIRAL	⊕	LMB	MAILBOX	⊕	IRM	RAMP METER	⊕	MPWL	PT., WALL LOCATION	⊕	TWZBCD_P	BARRICADE (TYPE III)	⊕	UUVT	UNKNOWN, VENT						
⊗	AST	SPIRAL TO TANGENT	⊕	LPB	PAPER BOX	⊕	IRWIS	RDWY WEATHER INFO. SENSOR	ROW ACQUISITION			⊕	TWZBCD_P	BARRICADE (TYPE III)	⊕	UUVT	UNKNOWN, VENT						
⊗	ATS	TANGENT TO SPIRAL	⊕	LPST	POST, SINGLE	⊕	ISP	SOLAR PANEL				⊕	MFS_P.T	FEE ACQUISITION	⊕	TWZCMS_P	CHANGEABLE MESSAGE SIGN (PVMS)	⊕	UJW	UNKNOWN, WELL			
△	AVEVT	VERTICAL EVENT POINT	⊕	LRB	ROCK, BOULDER	⊕	ISST	SPREAD SPECT. TRANSCEIVER	⊕	MEPS_P.T	EASEMENT, PERMANENT	⊕	TWZFLG_P	FLAGGER	⊕	UJW	UNKNOWN, WELL						
○	AVHIGH	VERTICAL HIGH POINT	⊕	LSHC	SHRUB, CONIFEROUS	⊕	ITDB	TELEPHONE DEMARCATION BLK	⊕	METS_P.T	EASEMENT, TEMPORARY	⊕	TWZFLG_P	FLAGGER	⊕	UJW	UNKNOWN, WELL						
○	AVLOW	VERTICAL LOW POINT	⊕	LSHD	SHRUB, DECIDUOUS	⊕	ITP	SUBSURFACE TEMP. PROBE	⊕	METS_P.T	EASEMENT, TEMPORARY	⊕	TWZFLG_P	FLAGGER	⊕	UJW	UNKNOWN, WELL						
BRIDGE			⊕	LTC	TREE, CONIFEROUS	⊕	IVTRT	VEHICLE TO RDWY TRANSCEIVER	⊕	METS_P.T	OCCUPANCY, TEMPORARY	⊕	TWZFLG_P	FLAGGER	⊕	UJW	UNKNOWN, WELL						
			⊕	LTD	TREE, DECIDUOUS	⊕	IWIMD	WEIGHT IN MOTION DETECTOR	⊕	METS_P.T	OCCUPANCY, TEMPORARY	⊕	MFS_P.T	FEE ACQUISITION W/O ACCESS	⊕	TWZFLG_P	FLAGGER	⊕	UJW	UNKNOWN, WELL			
CONTROL			⊕	LTS	TREE, STUMP	⊕	IWVR	WIRELESS VIDEO REPEATER	⊕	RES_P	ELEVATION, SPOT	⊕	TWZFLG_P	FLAGGER	⊕	UJW	UNKNOWN, WELL						
			⊕	LTW_P	TREE, WELL OR WALL	⊕	IWVRC	WIRELESS VIDEO RECEIVER	⊕	RGA	GUIDE RAIL, ANCHOR	⊕	RGP	GUIDE POST, SINGLE	⊕	TWZFLG_P	FLAGGER	⊕	UJW	UNKNOWN, WELL			
⊕	BSC	BRIDGE, SCUPPER	⊕	LUKP	UNKNOWN POINT	⊕	IWVTT	WIRELESS VIDEO TRANSMITTER	ROADWAY			⊕	TWZFLG_P	FLAGGER	⊕	UJW	UNKNOWN, WELL						
⊕	CBP	BASELINE, POINT	SEE LEG-1 FOR NOTES			⊕	IWVTT	WIRELESS VIDEO TRANSMITTER				⊕	RGA	GUIDE RAIL, ANCHOR	⊕	TWZFLG_P	FLAGGER	⊕	UJW	UNKNOWN, WELL			
○	CBPOL	BASELINE, POINT ON LINE				⊕	LUKP	UNKNOWN POINT	⊕	IWVTT	WIRELESS VIDEO TRANSMITTER	⊕	RGP	GUIDE POST, SINGLE	⊕	TWZFLG_P	FLAGGER	⊕	UJW	UNKNOWN, WELL			
⊕	CBSP	BASELINE, SPUR POINT				SEE LEG-1 FOR NOTES			⊕	IWVTT	WIRELESS VIDEO TRANSMITTER	⊕	RGA	GUIDE RAIL, ANCHOR	⊕	TWZFLG_P	FLAGGER	⊕	UJW	UNKNOWN, WELL			
⊗	CBTP	BASELINE, TIE POINT							⊕	LUKP	UNKNOWN POINT	⊕	IWVTT	WIRELESS VIDEO TRANSMITTER	⊕	RGP	GUIDE POST, SINGLE	⊕	TWZFLG_P	FLAGGER	⊕	UJW	UNKNOWN, WELL
⊕	CPBM	BENCHMARK							⊕	LUKP	UNKNOWN POINT	⊕	IWVTT	WIRELESS VIDEO TRANSMITTER	⊕	RGP	GUIDE POST, SINGLE	⊕	TWZFLG_P	FLAGGER	⊕	UJW	UNKNOWN, WELL
⊕	CPH	POINT, HORIZ. PHOTOGRAMMETRY							⊕	LUKP	UNKNOWN POINT	⊕	IWVTT	WIRELESS VIDEO TRANSMITTER	⊕	RGP	GUIDE POST, SINGLE	⊕	TWZFLG_P	FLAGGER	⊕	UJW	UNKNOWN, WELL
⊕	CPSM	POINT, SURVEY MARKER, PERM.							⊕	LUKP	UNKNOWN POINT	⊕	IWVTT	WIRELESS VIDEO TRANSMITTER	⊕	RGP	GUIDE POST, SINGLE	⊕	TWZFLG_P	FLAGGER	⊕	UJW	UNKNOWN, WELL
⊕	CPSV	POINT, VERT., PHOTOGRAMMETRY							⊕	LUKP	UNKNOWN POINT	⊕	IWVTT	WIRELESS VIDEO TRANSMITTER	⊕	RGP	GUIDE POST, SINGLE	⊕	TWZFLG_P	FLAGGER	⊕	UJW	UNKNOWN, WELL

AS-BUILT REVISIONS DESCRIPTION OF ALTERATIONS:	VETERAN'S ROAD CULVERT REPLACEMENT OVER FIVE MILE CREEK	PIN 1761.09	BRIDGES	CULVERTS	ALL DIMENSIONS IN ft UNLESS OTHERWISE NOTED	CONTRACT NUMBER D036296
	TOWN OF TICONDEROGA				LEGEND (2 OF 2)	DRAWING NO. LEG-2 SHEET NO. 4
	COUNTY: ESSEX	REGION: 1				
IT IS A VIOLATION OF LAW FOR ANY PERSON, UNLESS THEY ARE ACTING UNDER THE DIRECTION OF A LICENSED PROFESSIONAL ENGINEER, ARCHITECT, LANDSCAPE ARCHITECT, OR LAND SURVEYOR, TO ALTER AN ITEM IN ANY WAY. IF AN ITEM BEARING THE STAMP OF A LICENSED PROFESSIONAL IS ALTERED, THE ALTERING ENGINEER, ARCHITECT, LANDSCAPE ARCHITECT, OR LAND SURVEYOR SHALL STAMP THE DOCUMENT AND INCLUDE THE NOTATION "ALTERED BY" FOLLOWED BY THEIR SIGNATURE, THE DATE OF SUCH ALTERATION, AND A SPECIFIC DESCRIPTION OF THE ALTERATION.						
GPI GREENMAN-PEDERSEN, INC. CONSULTING ENGINEERS					TOWN OF TICONDEROGA	

GENERAL NOTES

- DESIGN SPECIFICATIONS: NYSOT LRFD BRIDGE DESIGN SPECIFICATIONS WITH ALL PROVISIONS IN EFFECT AS OF JANUARY 2021 (FOR DESIGN PURPOSES, COMPRESSIVE STRENGTH OF CONCRETE FOR SUBSTRUCTURES AT 28 DAYS: $f'_c = 3000$ psi.)
- LIVE LOAD: AASHTO HL-93 AND NYSOT DESIGN PERMIT VEHICLE
- CONSTRUCTION AND MATERIALS SPECIFICATIONS: STANDARD SPECIFICATIONS, CONSTRUCTION AND MATERIALS, NEW YORK STATE DEPARTMENT OF TRANSPORTATION, OFFICE OF ENGINEERING.
- DETAILS ON THE DRAWINGS LABELED AS "NOT TO SCALE" ARE INTENTIONALLY DRAWN NOT TO SCALE FOR VISUAL CLARITY. ALL OTHER DETAILS FOR WHICH NO SCALE IS SHOWN ARE DRAWN PROPORTIONAL AND ARE FULLY DIMENSIONED.
- ALL SHOP DRAWINGS SUBMITTED FOR THIS PROJECT SHALL BE IN US CUSTOMARY UNITS.
- THIS CULVERT SHALL BE MAINTAINED IN ACCORDANCE WITH THE GUIDELINES CONTAINED IN THE CURRENT EDITION OF THE AASHTO MAINTENANCE MANUAL FOR ROADWAYS AND BRIDGES.
- UNLESS OTHERWISE INDICATED ON THE PLANS, WORK TO BE PERFORMED UNDER THIS CONTRACT DOES NOT REQUIRE THE DISTURBING, DESTRUCTION OR REMOVAL OF ANY KNOWN MATERIALS CONTAINING ASBESTOS. UNLESS OTHERWISE INDICATED ON THE PLANS, IT IS THE EXPRESS INTENT OF THIS CONTRACT THAT THESE MATERIALS NOT BE DISTURBED IN ANY WAY. SHOULD THE CONTRACTOR BE FORCED TO DISTURB IN ANY WAY ANY SUCH MATERIALS, THE CONTRACTOR SHALL FIRST BE FAMILIAR WITH INDUSTRIAL CODE RULE 56 OF THE N.Y.S. DEPARTMENT OF LABOR. THE CONTRACTOR SHALL ALSO OBTAIN WRITTEN PERMISSION OF THE E.I.C. BEFORE PROCEEDING.
- THE LOAD RATINGS ARE IN ACCORDANCE WITH THE AASHTO MANUAL FOR BRIDGE EVALUATION. NEW SUPERSTRUCTURES SHALL MEET OR EXCEED 1.20 LRFD INVENTORY LOAD RATING FOR MOMENT, SHEAR, AND DEFLECTION PER NYSOT BRIDGE MANUAL, AND SHALL MEET OR EXCEED 1.00 ASD/LFD INVENTORY LOAD RATING FOR MOMENT, SHEAR, AND DEFLECTION.
- ALL DRAWINGS AND CALCULATIONS SUBMITTED BY THE CONTRACTOR FOR ENGINEER REVIEW SHALL BE IN PDF FORMAT AND SHALL BE EITHER 8.5" X 11" OR 11" X 17" WITH TEXT SIZE SHALL BE NO SMALLER THAN 1/16". SUBMISSIONS ILLEGIBLE WHEN PRINTED ON PAPER WILL BE REJECTED. FULL SIZE AND PAPER SUBMISSIONS SHALL NOT BE ACCEPTED OR REVIEWED. ALL DRAWINGS AND CALCULATIONS SHALL NOTE THE DESIGNER AND CHECKER. THE DESIGNER SHALL NOT CHECK THEIR OWN WORK. 11" X 17" DRAWINGS SHALL HAVE A BLANK SPACE THAT IS EITHER 2.5" X 5.5" OR 3.5" X 3.5" FOR PLACEMENT OF THE REVIEWER'S STAMP. 8.5" X 11" DRAWINGS SHALL HAVE AN APPROVAL COVER SHEET IF SPACE FOR THE STAMP DOES NOT FIT ON THE ACTUAL DRAWING.
- DIMENSIONS FOR THICKNESSES OF STEEL ROLLED ANGLE SHAPES AND STRUCTURAL TUBING ARE SHOWN ACCORDING TO THE AISC MANUAL.

FOUNDATION NOTES

- HIGHWAY EMBANKMENT MATERIAL (FROM HIGHWAY ESTIMATE OR FROM STRUCTURE EXCAVATION BACKFILL) AND SELECT STRUCTURE FILL, ITEM 203.21, SHALL BE PLACED SIMULTANEOUSLY, IN CONTACT, ON BOTH SIDES OF THE VERTICAL PAYMENT LINE.
- THE COST OF WATER USED FOR COMPACTION OF SELECT FILL ITEMS SHALL BE INCLUDED IN THE UNIT PRICE BID FOR ITEM 203.21 - SELECT STRUCTURE FILL.
- ALL PLACEMENTS OF SELECT STRUCTURAL FILL, ITEM 203.21, SHALL BE COMPACTED TO 95 PERCENT OF STANDARD PROCTOR MAXIMUM DENSITY.

COFFERDAM AND HYDRAULIC NOTES

- SHOULD THE CONTRACTOR ELECT TO LAY BACK A PORTION OF THE EXISTING EARTH ADJACENT TO AN EXCAVATION REQUIRING A COFFERDAM, ANY REQUIRED EXTENSIONS OF THE COFFERDAM NECESSARY TO KEEP WATER FROM ENTERING THE EXCAVATION SHALL BE FURNISHED AND PLACED AT NO COST TO THE TOWN AND COUNTY.
- WHERE A COFFERDAM IS USED, THE COST OF DEWATERING THE ENTIRE EXCAVATION, REGARDLESS OF THE SOURCE OF WATER, SHALL BE INCLUDED IN THE UNIT PRICE BID FOR THE COFFERDAM ITEM.
- THE COFFERDAMS ARE TO BE CONTRACTOR DESIGNED. A COFFERDAM PLAN SHALL BE SUBMITTED TO THE ENGINEER FIFTEEN (15) DAYS PRIOR TO INSTALLATION.
- DEWATERING OF THE COFFERDAM SHALL BE ACCOMPLISHED BY PUMPING THE WATER TO AN APPROVED UPLAND VEGETATED AREA OUTSIDE OF THE STREAMBED AS SHOWN ON THE PLANS AND/OR APPROVED BY THE E.I.C. TEMPORARY SOIL EROSION AND WATER POLLUTION CONTROL, SUCH AS STRAW BALES OR APPROVED EQUAL, MAY BE REQUIRED AS DETERMINED BY THE E.I.C. NO SETTLEMENT BASIN SHALL BE CONSTRUCTED.
- ORDINARY HIGH WATER IS ESTIMATED TO BE 304.40 FEET. THIS IS DEFINED AS THE WATER SURFACE ELEVATION FOR THE MEAN ANNUAL FLOOD, WHICH IS THE FLOOD THAT HAS A RECURRENCE INTERVAL OF 2.33 YEARS.

SUPERSTRUCTURE NOTES

- THE ASSUMED UNFACTORED SPAN UNIT REACTIONS ARE SHOWN ON THE THREE-SIDED STRUCTURE FRAMING PLAN. IF THE REACTIONS OF THE CONTRACTOR'S PROPOSED STRUCTURE EXCEED THOSE VALUES, THE CONTRACTOR SHALL ENGAGE THE SERVICES OF A NYS LICENSED PROFESSIONAL ENGINEER TO VERIFY OR REDESIGN THE SUBSTRUCTURES SHOWN IN THESE CONTRACT DRAWINGS. THE CALCULATIONS SHALL BE PREPARED, STAMPED AND SIGNED BY SAID ENGINEER AND SUBMITTED TO THE TOWN AND COUNTY FOR REVIEW AND APPROVAL PRIOR TO BEGINNING SUBSTRUCTURE CONSTRUCTION. ANY ADDITIONAL COSTS ASSOCIATED WITH REDESIGNING OR VERIFYING SUBSTRUCTURE DETAILS SHALL BE AT THE CONTRACTOR'S EXPENSE.
- THE PRECASTER SHALL ENSURE THAT THE OWNER'S QUALITY ASSURANCE REPRESENTATIVE IS ON SITE PRIOR TO AND DURING ALL CONCRETE CASTING OPERATIONS. THE PRECASTER ASSUMES RESPONSIBILITY TO CONTACT THE OWNER'S REPRESENTATIVE AT LEAST 3 BUSINESS DAYS PRIOR TO SUCH CASTING OPERATIONS. ANY CONCRETE ELEMENT THAT IS CAST WITHOUT THE OWNER'S REPRESENTATIVE PRESENT SHALL BE REJECTED PRIOR TO SHIPMENT TO THE SITE AT NO COST TO THE TOWN AND COUNTY.
- THE PRECASTER SHALL SUBMIT A FABRICATION SCHEDULE AND ANY ANTICIPATED PRECAST REPAIR PROCEDURES IN THEIR SHOP DRAWING SUBMITTAL. ALL REPAIRS SHALL BE DONE IN ACCORDANCE WITH THE APPROVED SUBMITTAL. ANY CONCRETE ELEMENT THAT IS REPAIRED USING NON-APPROVED PROCEDURES SHALL BE REJECTED PRIOR TO SHIPMENT TO THE SITE AT NO COST TO THE TOWN AND COUNTY.
- THE CONTRACTOR SHALL ENSURE COFFERDAMS AND ANY REQUIRED ROCK BACKFILL WILL ALLOW FOR RETENTION OF ANY REQUIRED TENSIONING RODS ON THE THREE SIDED SPAN UNITS UNTIL ALL UNITS ARE PLACED, GROUTED AND BACKFILLED.
- ALL PRECASTING PRODUCED IN ACCORDANCE WITH MATERIALS SPECIFICATION 704-03 GROUP 1 OR GROUP 3 SHALL FOLLOW THE PROVISIONS IN THE NYSOT PRECAST CONCRETE CONSTRUCTION MANUAL IN EFFECT ON THE CONTRACT LETTING DATE.
- THREADED INSERT AND EMBEDMENT LENGTH DETAILS AND/OR KEYWAYS FOR CONNECTING WINGWALLS TO THE THREE-SIDED STRUCTURE SHALL BE PROVIDED BY THE CONTRACTOR WITH THE SHOP DRAWINGS. INSERTS SHALL BE EPOXY-COATED.
- ALL REINFORCING FOR THE REINFORCED CONCRETE SPAN UNITS SHALL BE UNCOATED. THE REINFORCEMENT SHALL MEET ALL THE REQUIREMENTS OF ITEM 556.0201. THE COST OF REINFORCING SHALL BE INCLUDED UNDER THE PRECAST ITEMS.
- PRECAST DETAILS SHOWN IN THESE CONTRACT DRAWINGS ARE INTENDED TO BE NON-PROPRIETARY IN NATURE.
- THE LOAD RATING TABLE FOUND ON THE THREE-SIDED STRUCTURE FRAMING PLAN SHALL BE FILLED IN BY THE E.I.C. FROM INFORMATION PROVIDED BY THE CONTRACTOR. THE LOAD RATINGS SHALL BE ON THE PRODUCTION NOTE SHEET OF THE SHOP DRAWINGS. THE CONTRACTOR SHALL INCLUDE ALL LOAD RATING COMPUTATIONS IN THE DESIGN CALCULATION SUBMITTAL.
- PRECAST UNITS SHALL BE DESIGNED ASSUMING UNDRAINED CONDITIONS.
- PER THE REQUIREMENTS OF §107-05, AN ERECTION PLAN FOR THE INSTALLATION OF THE PRECAST CONCRETE SPAN UNITS, SIGNED BY A LICENSED AND REGISTERED PROFESSIONAL ENGINEER IN THE STATE OF NEW YORK, SHALL BE SUBMITTED TO THE ENGINEER THIRTY (30) DAYS PRIOR TO INSTALLATION.
- ALL STEEL BRIDGE RAILING AND/OR CONCRETE BARRIER IN THIS CONTRACT IS DESIGNED TO PROVIDE A TL-4 SERVICE LEVEL FOR THE PURPOSES OF RAILING AND/OR BARRIER ATTACHMENT DESIGN TO DECK SLABS AND/OR WALLS AS SHOWN IN THE PLANS. DECKS AND/OR WALLS WITH ATTACHMENTS TO RAILING AND/OR BARRIER SHALL BE ADEQUATELY REINFORCED TO PROVIDE TRANSFER OF VEHICLE IMPACT PER NYSOT LRFD BRIDGE DESIGN SPECIFICATIONS CHAPTER 13 OR THE NYSOT BRIDGE MANUAL CHAPTER 6.
- THE PRECASTER SHALL PROVIDE PERMANENT PHYSICAL ATTACHMENT ON THE FILL SIDE OF PRECAST WALLS BETWEEN ALL PRECAST SECTIONS OF A CONTINUOUS WINGWALL OR CONTINUOUS CULVERT BARREL. THIS CAN BE ACHIEVED BY PLATES OR THREADED RODS AND ANGLES BOLTED BY THE CONTRACTOR TO INSERTS CAST BY THE PRECASTER OR BY OTHER MEANS SHOWN ON THE SHOP DRAWINGS TO BE INSTALLED BY THE CONTRACTOR. THE USE OF TEMPORARY MEANS TO DRAW JOINTS TOGETHER WILL ONLY BE PERMITTED IF THE JOINTS HAVE EMBEDDED REINFORCEMENT ACROSS THE JOINT AND HAVE BEEN FULLY GROUTED OR CAST-IN-PLACE CONCRETE HAS BEEN INSTALLED AND CURED PRIOR TO REMOVAL OF THE PHYSICAL ATTACHMENT.

REMOVAL NOTES

- EXISTING SUBSTRUCTURE SHALL BE REMOVED WITHIN THE LIMITS SHOWN ON THE PLANS UNDER ITEM 202.19.
- EXISTING SUPERSTRUCTURE SHALL BE REMOVED UNDER ITEM 202.120001.
- ACCORDING TO THE REQUIREMENTS OF §202-3.01 GENERAL AND SAFETY REQUIREMENTS, A REMOVAL PLAN, SIGNED BY A LICENSED AND REGISTERED PROFESSIONAL ENGINEER IN THE STATE OF NEW YORK SHALL BE SUBMITTED TO THE ENGINEER THIRTY (30) DAYS PRIOR TO BEGINNING THE DEMOLITION.
- RECORD PLANS FOR THIS STRUCTURE ARE NOT AVAILABLE.


RECONSTRUCTION NOTES

- DUE TO THE NATURE OF RECONSTRUCTION PROJECTS, THE EXACT EXTENT OF RECONSTRUCTION WORK CANNOT BE ACCURATELY DETERMINED PRIOR TO THE COMMENCEMENT OF WORK. THESE CONTRACT DOCUMENTS HAVE BEEN PREPARED BASED ON FIELD INSPECTION AND OTHER INFORMATION AVAILABLE AT THIS TIME. ACTUAL FIELD CONDITIONS MAY REQUIRE MODIFICATIONS TO CONSTRUCTION DETAILS AND WORK QUANTITIES. THE CONTRACTOR SHALL PERFORM THE WORK IN ACCORDANCE WITH FIELD CONDITIONS.
- THE CONTRACTOR SHALL PERFORM ALL WORK WITH CARE SO THAT ANY MATERIALS WHICH ARE TO REMAIN IN PLACE, OR WHICH ARE TO REMAIN THE PROPERTY OF THE TOWN AND COUNTY, WILL NOT BE DAMAGED. IF THE CONTRACTOR DAMAGES ANY MATERIALS WHICH ARE TO REMAIN IN PLACE OR WHICH ARE TO REMAIN THE PROPERTY OF THE TOWN AND COUNTY THE DAMAGED MATERIALS SHALL BE REPAIRED OR REPLACED IN A MANNER SATISFACTORY TO THE ENGINEER AT THE EXPENSE OF THE CONTRACTOR.
- WHENEVER ITEMS IN THE CONTRACT REQUIRE MATERIALS TO BE REMOVED AND DISPOSED OF, THE COST OF SUPPLYING A DISPOSAL AREA AND TRANSPORTATION TO THAT AREA SHALL BE INCLUDED IN THE UNIT PRICES BID FOR THOSE ITEMS.
- DURING REMOVAL OPERATIONS, THE CONTRACTOR SHALL NOT DROP WASTE CONCRETE, DEBRIS, AND OTHER MATERIAL TO THE AREA BELOW THE CULVERT EXCEPT WHERE THE PLANS SPECIFICALLY PERMIT THE DROPPING OF MATERIAL. PLATFORMS, NETS, SCREENS OR OTHER PROTECTIVE DEVICES SHALL BE USED TO CATCH THE MATERIAL. IF ADEQUATE PROTECTIVE DEVICES ARE NOT BEING EMPLOYED, THE WORK WILL BE STOPPED UNTIL ADEQUATE PROTECTION IS PROVIDED.
- ALL MATERIAL FALLING ON THE AREA BELOW AND ADJACENT TO THE CULVERT SHALL BE REMOVED AND DISPOSED OF BY THE CONTRACTOR AT NO COST TO THE TOWN AND COUNTY.
- THE COST OF FURNISHING, INSTALLING, MAINTAINING, REMOVING AND DISPOSING OF ALL PLATFORMS, NETS, SCREENS OR OTHER PROTECTIVE DEVICES SHALL BE INCLUDED IN THE PRICES BID FOR THE APPROPRIATE ITEMS OF THE CONTRACT.

STREAM PROTECTION NOTE

- DURING THE COURSE OF CONSTRUCTION, THE CONTRACTOR SHALL CONDUCT OPERATIONS IN SUCH A MANNER AS TO PREVENT OR REDUCE TO A MINIMUM ANY DAMAGE TO ANY STREAM FROM POLLUTION BY DEBRIS, SEDIMENT, OR OTHER FOREIGN MATERIAL, OR FROM MANIPULATION OF EQUIPMENT AND/OR MATERIALS IN OR NEAR SUCH STREAMS. THE CONTRACTOR SHALL NOT RETURN DIRECTLY TO A STREAM ANY WATER WHICH HAS BEEN USED FOR WASH PURPOSES OR OTHER SIMILAR OPERATIONS WHICH CAUSE THIS WATER TO BECOME POLLUTED WITH SAND, SILT, CEMENT, OIL, OR OTHER IMPURITIES. IF THE CONTRACTOR USES WATER FROM A STREAM, THE CONTRACTOR SHALL CONSTRUCT AN INTAKE OR TEMPORARY DAM REQUIRED TO PROTECT AND MAINTAIN WATER RIGHTS AND TO SUSTAIN FISH LIFE DOWNSTREAM.

AFFIX SEAL: GREENMAN - PEDERSEN, INC ON: APRIL 15, 2021	ALTERED BY: ON:
	

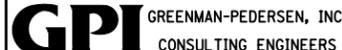AS-BUILT REVISIONS DESCRIPTION OF ALTERATIONS:	VETERAN'S ROAD CULVERT REPLACEMENT	PIN 1761.09	BRIDGES	CULVERTS	ALL DIMENSIONS IN ft UNLESS OTHERWISE NOTED	CONTRACT NUMBER D036296
	OVER FIVE MILE CREEK					
	TOWN OF TICONDEROGA					
COUNTY: ESSEX	REGION: 1	GENERAL NOTES (1 OF 2)		DRAWING NO. GNN-1 SHEET NO. 5		
IT IS A VIOLATION OF LAW FOR ANY PERSON, UNLESS THEY ARE ACTING UNDER THE DIRECTION OF A LICENSED PROFESSIONAL ENGINEER, ARCHITECT, LANDSCAPE ARCHITECT, OR LAND SURVEYOR, TO ALTER AN ITEM IN ANY WAY. IF AN ITEM BEARING THE STAMP OF A LICENSED PROFESSIONAL IS ALTERED, THE ALTERING ENGINEER, ARCHITECT, LANDSCAPE ARCHITECT, OR LAND SURVEYOR SHALL STAMP THE DOCUMENT AND INCLUDE THE NOTATION "ALTERED BY" FOLLOWED BY THEIR SIGNATURE, THE DATE OF SUCH ALTERATION, AND A SPECIFIC DESCRIPTION OF THE ALTERATION.					 	

HIGHWAY GENERAL NOTES

- CURRENT NATIONAL "MANUAL OF UNIFORM TRAFFIC CONTROL DEVICES" (MUTCD) WITH NEW YORK STATE SUPPLEMENT SHALL BE IN EFFECT FOR THIS PROJECT
- ADDITIONAL NOTES MAY BE FOUND ON SUBSEQUENT DRAWINGS. SUCH NOTES, WHILE PERTAINING TO THE SPECIFIC DRAWING THEY ARE PLACED ON, ALSO SUPPLEMENT THE GENERAL NOTES LISTED HEREIN.
- THE CONTRACTOR SHALL EXAMINE AND VERIFY IN THE FIELD ALL EXISTING CONDITIONS AND DIMENSIONS WITH THOSE SHOWN ON THE PLANS. THE CONTRACTOR SHALL USE THE FIELD CONDITIONS AND DIMENSIONS, AND MAKE THE APPROPRIATE CHANGES TO THOSE SHOWN ON THE PLANS AS APPROVED BY THE ENGINEER. THE RESULTS OF THIS CHECK OF CONDITIONS AND DIMENSIONS SHALL BE SO NOTED ON THE DRAWINGS SUBMITTED FOR APPROVAL.
- THERE SHALL BE NO CLAIM AGAINST THE TOWN AND COUNTY BY THE CONTRACTOR FOR WORK PERTAINING TO MODIFICATIONS AS MAY BE REQUIRED DUE TO ANY DIFFERENCE BETWEEN ACTUAL FIELD CONDITIONS AND THOSE SHOWN BY THE DETAILS AND DIMENSIONS ON THE CONTRACT PLANS. THE CONTRACTOR WILL BE PAID AT THE UNIT BID PRICE FOR THE ACTUAL QUANTITIES OF MATERIALS USED OR FOR THE WORK PERFORMED, AS INDICATED BY THE VARIOUS ITEMS IN THE CONTRACT.
- AT ALL TIMES, THE CONTRACTOR SHALL TAKE MEASURES TO PROVIDE POSITIVE DRAINAGE OF SURFACE RUNOFF FROM THE TRAVEL LANES AND CONTROL OF THE RUNOFF TO PREVENT EROSION, POLLUTION, SEDIMENTATION OR OTHER DISCHARGES WHICH WOULD AFFECT PROPERTIES ADJACENT TO THE WORK SITE. ALL MEASURES TAKEN TO PROVIDE POSITIVE DRAINAGE SHALL BE APPROVED BY THE ENGINEER PRIOR TO IMPLEMENTATION. THE COST FOR THIS WORK SHALL BE INCLUDED IN THE PRICE BID FOR VARIOUS ITEMS IN THE CONTRACT.
- THE CONTRACTOR SHOULD NOTE THAT ADDITIONAL WORK MAY BE REQUIRED AS THE CONTRACT PROGRESSES WHICH IS NOT SHOWN OR NOTED ON THE PLANS. THIS WORK SHALL BE PERFORMED BY THE CONTRACTOR AS ORDERED BY THE ENGINEER AND PAYMENT SHALL BE MADE AT THE BID PRICE FOR THE APPROPRIATE ITEMS.
- NO PAYMENT SHALL BE MADE FOR WORK CALLED FOR BY NOTES ON THE PLANS, IN THE SPECIFICATIONS, OR UNDER THE HEADING GENERAL NOTES UNLESS PAYMENT IS SPECIFICALLY INDICATED BY ITEM NUMBER. THE COST OF WORK FOR WHICH NO PAYMENT IS INDICATED SHALL BE INCLUDED IN THE UNIT PRICES BID FOR THE VARIOUS ITEMS IN THE CONTRACT.
- THE CONTRACTOR SHALL PROVIDE ALL TEMPORARY SUPPORTS, BRACING OR OTHER DEVICES THAT MAY BE REQUIRED OR THAT MAY BE DIRECTED BY THE ENGINEER TO PROTECT THE SAFETY OF ADJACENT STRUCTURES, ROADWAYS OR THE VARIOUS ITEMS IN THE CONTRACT. NO SEPARATE PAYMENT SHALL BE MADE.
- PAVED AREAS DISTURBED BY THE CONTRACTOR WHICH ARE NOT PART OF THE WORK TO BE PERFORMED UNDER THIS CONTRACT, SHALL BE RESTORED TO AN ACCEPTABLE CONDITION AS SPECIFIED BY AND SATISFACTORY TO THE ENGINEER. NO PAYMENT WILL BE MADE FOR RESTORING AREAS NOT PART OF THIS CONTRACT.
- PROVISIONS TO DE-WATER EXCAVATIONS, DUE TO CONSTRUCTION OPERATIONS ALONG THE PROJECT MAY BE REQUIRED. THERE SHALL BE NO DIRECT PAYMENT FOR ANY DE-WATERING SYSTEMS. COST SHALL BE INCLUDED IN THE PRICE BID FOR VARIOUS ITEMS IN THE CONTRACT.
- THE CONTRACTOR SHALL KEEP ALL DRAINAGE FACILITIES, WITHIN THE CONTRACT LIMITS, CLEAN AND FULLY OPERATIONAL AT ALL TIMES (A.O.B.E.). THIS WORK SHALL BE INCLUDED UNDER VARIOUS ITEMS IN THE CONTRACT.
- THE CONTRACTOR SHALL PROVIDE SURVEY AND STAKEOUT AS REQUIRED AND IN ACCORDANCE WITH SECTION 625 OF THE STANDARD SPECIFICATIONS. COST FOR THIS WORK SHALL BE INCLUDED UNDER ITEM 625.01-SURVEY OPERATIONS.
- THE CONTRACTOR IS TO VISIT THE SITE BEFORE BIDDING TO BECOME FAMILIAR WITH THE PRESENT CONDITIONS AND TO JUDGE THE EXTENT AND NATURE OF THE WORK TO BE DONE UNDER THIS CONTRACT. NO EXTRA COMPENSATION WILL BE ALLOWED BECAUSE OF FAILURE TO INCLUDE IN THE BID ALL ITEMS AND MATERIALS WHICH ARE REQUIRED TO BE FURNISHED IN ACCORDANCE WITH THE CONTRACT DOCUMENTS.
- THE CONTRACTOR SHALL BE REQUIRED TO PROTECT HIS WORKERS AT ALL TIMES IN CONFORMANCE WITH APPLICABLE OSHA REGULATIONS.


RIGHT-OF-WAY NOTES

- FOR THIS PROJECT THE PUBLIC RIGHT-OF-WAY, AS REFERENCED IN THE SUBSEQUENT RIGHT-OF-WAY NOTES, SHALL ONLY INCLUDE THE PUBLIC RIGHT-OF-WAY.
- ALL WORK TO BE PERFORMED UNDER THIS CONTRACT WILL BE WITHIN THE PUBLIC RIGHT-OF-WAY (ROW) IN ACCORDANCE WITH SECTION 105-15 OF THE STANDARD SPECIFICATIONS. THE CONTRACTOR IS TO ASSURE HIMSELF THAT ALL WORK IS PERFORMED WITHIN THE ROW, INCLUDING BUT NOT LIMITED TO VEHICLE ACCESS; STORAGE OF EQUIPMENT, MATERIALS DEBRIS AND WASTE; LANDSCAPING; VEGETATION REMOVAL AND MANAGEMENT; GRADING, SEEDING AND THE INSTALLATION OF TURF; AND THE INSTALLATION OF ANY FENCES OR PROTECTIVE BARRIER.
- IF THE CONTRACTOR IS UNABLE TO IDENTIFY THE LIMITS OF THE RIGHTS-OF-WAY WHEN THE CONTRACT CALLS FOR WORK IN THOSE VICINITIES, THE CONTRACTOR MUST CONTACT THE PROJECT ENGINEER FOR DEFINITIVE BOUNDARY DETERMINATIONS BEFORE ANY WORK MAY BE INITIATED AT THOSE LOCATIONS (STANDARD SPECIFICATION SECTIONS 105-10 AND 625).
- IN ACCORDANCE WITH SECTION 105-15 OF THE STANDARD SPECIFICATIONS, RELEASES FOR ANY NON-ESSENTIAL CONTRACT WORK OUTSIDE OF THE EXISTING RIGHTS-OF-WAY, INCLUDING PLANTINGS, LANDSCAPING OR DRIVEWAY ENHANCEMENT, WILL BE PROVIDED BY THE PROJECT ENGINEER AND IN NO INSTANCE ARE TO BE SECURED BY THE CONTRACTOR. THE CONTRACTOR SHALL NOT INVADE UPON PRIVATE PROPERTIES, LANDS OR BUILDINGS OUTSIDE OF THE RIGHTS-OF-WAY FOR ANY REASON WITHOUT FIRST SECURING WRITTEN PERMISSION FROM THE PROPERTY OWNER (STANDARD SPECIFICATIONS SECTION 105-15).
- THE CONTRACTOR WILL BE HELD LIABLE FOR ANY DAMAGES DONE. ANY SUCH INJURIES OR DAMAGES SHALL BE SATISFACTORILY REPAIRED OR ITEMS REPLACED AT THE CONTRACTOR'S EXPENSE (STANDARD SPECIFICATIONS SECTION 107-08).

UTILITY NOTES

- AN UNDERGROUND WATER LINE OWNED BY THE TOWN IS LOCATED IN THE EXISTING BRIDGE DECK. THE CONTRACTOR WILL COORDINATE WITH THE TOWN AND THEIR REPRESENTATIVES TO MAINTAIN SERVICE DURING CONSTRUCTION. A TEMPORARY LINE WILL BE INSTALLED PRIOR TO THE DEMOLITION OF THE CULVERT. A NEW LINE WILL BE INSTALLED BY THE CONTRACTOR AS SHOWN ON THESE PLANS.
- OVERHEAD ELECTRICAL LINES OWNED BY NATIONAL GRID WILL BE RELOCATED PRIOR TO CONTRACT. OVERHEAD COMMUNICATION LINES OWNED BY VERIZON WILL BE RELOCATED PRIOR TO CONTRACT. EXISTING AND RELOCATED LOCATIONS ARE SHOWN ON THESE PLANS.
- EXACT LOCATIONS OF UTILITIES, PUBLIC AND/OR PRIVATE, SHALL BE DETERMINED IN THE FIELD BY THE CONTRACTOR. PRIOR TO ANY EXCAVATION, THE CONTRACTOR IS TO CALL DIG SAFELY N.Y. TO HAVE UNDERGROUND UTILITIES LOCATED.
- IN THE EVENT THE CONTRACTOR DAMAGES AN EXISTING UTILITY SERVICE, CAUSING THE INTERRUPTION IN SAID SERVICE, THE CONTRACTOR SHALL IMMEDIATELY COMMENCE WORK TO RESTORE SERVICE AND MAY NOT CEASE WORK UNTIL SERVICE IS RESTORED. ALL COSTS TO REPAIR OR REPLACE DAMAGED UTILITIES SHALL BE AT THE EXPENSE OF THE CONTRACTOR. IF THE CONTRACTOR DOES NOT MAKE IMMEDIATE NECESSARY REPAIRS, THE RESPECTIVE OWNING COMPANIES OR MUNICIPAL FORCES MAY DO THE WORK, AND THE COST THEREOF CHARGED TO THE CONTRACTOR.
- THE CONTRACTOR SHALL PROTECT ALL UNDERGROUND UTILITIES TO REMAIN IN PLACE FROM DAMAGE DURING THE CONSTRUCTION. METHODS OF PROTECTION MAY INCLUDE STEEL PLATES OVER THE UTILITY SO THAT WHEEL LOADING FROM CONSTRUCTION VEHICLES DO NOT DAMAGE THE UTILITY. THE COST OF PROVIDING PROTECTION OF UNDERGROUND UTILITIES SHALL BE INCLUDED UNDER VARIOUS ITEMS IN THE CONTRACT.

AFFIX SEAL: GREENMAN - PEDERSEN, INC ON: APRIL 15, 2021		ALTERED BY: ON:							
		AS-BUILT REVISIONS DESCRIPTION OF ALTERATIONS:							
		<table border="1"> <tr> <td>VETERAN'S ROAD CULVERT REPLACEMENT</td> <td>PIN 1761.09</td> </tr> <tr> <td>OVER FIVE MILE CREEK</td> <td></td> </tr> <tr> <td>TOWN OF TICONDEROGA</td> <td></td> </tr> <tr> <td>COUNTY: ESSEX</td> <td>REGION: 1</td> </tr> </table>		VETERAN'S ROAD CULVERT REPLACEMENT	PIN 1761.09	OVER FIVE MILE CREEK		TOWN OF TICONDEROGA	
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COUNTY: ESSEX	REGION: 1												
GENERAL NOTES (2 OF 2)				DRAWING NO. GNN-2 SHEET NO. 6									
													

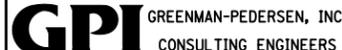IT IS A VIOLATION OF LAW FOR ANY PERSON, UNLESS THEY ARE ACTING UNDER THE DIRECTION OF A LICENSED PROFESSIONAL ENGINEER, ARCHITECT, LANDSCAPE ARCHITECT, OR LAND SURVEYOR, TO ALTER AN ITEM IN ANY WAY. IF AN ITEM BEARING THE STAMP OF A LICENSED PROFESSIONAL IS ALTERED, THE ALTERING ENGINEER, ARCHITECT, LANDSCAPE ARCHITECT, OR LAND SURVEYOR SHALL STAMP THE DOCUMENT AND INCLUDE THE NOTATION "ALTERED BY" FOLLOWED BY THEIR SIGNATURE, THE DATE OF SUCH ALTERATION, AND A SPECIFIC DESCRIPTION OF THE ALTERATION.

WORK ZONE TRAFFIC CONTROL GENERAL NOTES

- THE FOLLOWING NOTES ARE INTENDED TO SUPPLEMENT AND CLARIFY THE REQUIREMENTS SET FORTH IN SECTION 619 OF THE NYS STANDARD SPECIFICATIONS AND SECTION 619 OF THE NYS STANDARD SHEETS.
- ALL WORK ZONE TRAFFIC CONTROL ACTIVITIES SHALL BE PERFORMED IN ACCORDANCE WITH THE NYS DOT STANDARD SPECIFICATIONS, THE NATIONAL MANUAL OF UNIFORM TRAFFIC CONTROL DEVICES (MUTCD) AND NYS SUPPLEMENT.
- TRAFFIC SHALL BE MAINTAINED IN ACCORDANCE WITH ALL PROVISIONS OF ITEM 619.01 - BASIC WORK ZONE TRAFFIC CONTROL, OR AS AMENDED ON THESE PLANS, FOR THE DURATION OF THE PROJECT.
- THE CONTRACTOR MAY SUBMIT REVISIONS TO THESE PLANS, IN WRITING, TO THE ENGINEER FOR APPROVAL, HOWEVER ANY COSTS RESULTING FROM THESE CHANGES SHALL BE THE RESPONSIBILITY OF THE CONTRACTOR.
- ALL VEHICLES AND EQUIPMENT THAT SHALL BE MOVING IN AND OUT OF TRAFFIC AT WORK AREAS SHALL BE EQUIPPED WITH AN APPROVED AMBER ROTATING SAFETY LIGHT. THIS LIGHT SHALL BE MOUNTED SO AS TO BE EASILY SEEN BY APPROACHING TRAFFIC.
- VEHICLES BELONGING TO THE CONTRACTOR, OR THE CONTRACTOR'S EMPLOYEES, SHALL NOT BE PARKED ON THE PAVEMENT OR SHOULDERS, OR WITHIN 30 FEET OF THE EDGE OF PAVEMENT ALONG OR ADJACENT TO OPEN TRAVEL LANES.
- THE CONTRACTOR SHALL NOT PARK EQUIPMENT, NOR STORE MATERIAL, OVERNIGHT WHERE IT IS DEEMED BY THE ENGINEER TO BE A SAFETY HAZARD TO TRAFFIC.
- DRIVING AGAINST TRAFFIC AT ANY TIME, REGARDLESS OF WHETHER OR NOT THE AREA HAS BEEN CLOSED TO TRAFFIC, SHALL NOT BE PERMITTED, EXCEPT FOR TRAFFIC CONE PICK-UP OR AS SPECIFICALLY PERMITTED BY THE ENGINEER.
- ESCORT VEHICLES EQUIPPED WITH AN AMBER LIGHT OR AN OPERATING ARROW PANEL WILL BE REQUIRED WHEN TRANSPORTING SLOW MOVING CONSTRUCTION EQUIPMENT ALONG ANY PORTION OF THE ROADWAY OPEN TO TRAFFIC.
- WHEN REOPENING DRIVING LANES TO TRAFFIC, THE CONTRACTOR SHALL START BY MOVING THE DEVICES AT THE FAR END OF THE LANE CLOSURE AND WORKING TOWARDS THE SIGNS AT THE BEGINNING OF THE LANE CLOSURE. THE SIGNS ARE NOT TO BE TAKEN DOWN UNTIL ALL TRAFFIC CONTROL DEVICES HAVE BEEN REMOVED.
- SEE TABLE 619-3 IN THE NYS DOT STANDARD SPECIFICATIONS FOR REQUIRED TREATMENT OF PAVEMENT EDGE DROP-OFFS AND DELINEATION.
- EXCAVATIONS THAT PRODUCE DROP-OFFS ON BOTH SIDES OF THE TRAVEL WAYS AT THE SAME TIME SHALL NOT BE PERMITTED. SHOULDER AREAS SHALL BE PREPARED TO RECEIVE THE SHOULDER PAVEMENT MATERIAL IMMEDIATELY AHEAD OF SHOULDER PAVING OPERATIONS TO MINIMIZE THE TIME A DROP-OFF CONDITION EXISTS. "NO SHOULDER" (NYW4-13) SIGNS SHALL BE ERECTED A MINIMUM OF 500 FEET APART THROUGHOUT THE PROJECT WHEREVER A DROP-OFF EXISTS. LOW SHOULDER SIGNS (W8-9) MAY ALSO BE REQUIRED. IN NO CASE SHALL AN EDGE DROP-OFF EXCEED 3 INCHES.
- COSTS FOR ALL TEMPORARY SIGNS FOR WORK ZONE TRAFFIC CONTROL SHALL BE INCLUDED UNDER ITEM 619.01.
- THE MOUNTING OF ALL TEMPORARY CONSTRUCTION SIGNS SHALL BE PER FIGURE 6F-1 CONVENTIONAL ROAD IN THE MUTCD.
- THE COST OF PROVIDING AND MAINTAINING SAFE AND ADEQUATE INGRESS AND EGRESS TO AND FROM INTERSECTING HIGHWAYS, HOMES AND COMMERCIAL ESTABLISHMENTS AT ALL TIMES, TO THE SATISFACTION OF THE ENGINEER, SHALL BE BORNE BY THE CONTRACTOR, INCLUDING PROVIDING TEMPORARY ASPHALT PAVEMENT TO MAINTAIN THIS ACCESS.
- IF THE ENGINEER NOTIFIES THE CONTRACTOR OR HIS SUPERINTENDENT OF ANY HAZARDOUS CONSTRUCTION PRACTICES, ALL OPERATIONS IN THAT AREA SHALL BE DISCONTINUED AND IMMEDIATE REMEDIAL ACTION SHALL BE TAKEN TO THE SATISFACTION OF THE ENGINEER BEFORE WORK IS RESUMED.

WORK ZONE TRAFFIC CONTROL GENERAL NOTES CONT.

- THE CONTRACTOR SHALL BE RESPONSIBLE FOR MAKING SURE THAT ALL SIGNS, CONES, FLASHERS, BARRIERS, ETC. ARE IN PLACE AND IN GOOD CONDITION. THE SOLE JUDGE OF THE EFFECTIVENESS OF THE CONTRACTOR'S EFFORTS TOWARDS THE PROTECTION OF TRAFFIC AND PERSONNEL SHALL BE THE ENGINEER.
- FLAGGERS SHALL BE LOCATED AT ALL ACTIVE WORK AREAS AND AT OTHER LOCATIONS WITHIN A WORK AREA WHERE RESTRICTED SIGHT DISTANCE IMPEDES THE FLOW OF TRAFFIC OR A.O.B.E.
- EXISTING TRAFFIC SIGNS SHALL BE COVERED AND UNCOVERED AS NECESSARY DURING CONSTRUCTION. COST TO BE INCLUDED UNDER ITEM 619.01.
- IF IN THE ENGINEER'S JUDGMENT, FLAGS ON SIGNS ARE NECESSARY DUE TO LIMITED SIGHT DISTANCE. THEY SHALL BE PROVIDED BY THE CONTRACTOR. COST SHALL BE INCLUDED IN ITEM 619.01.
- AT NO TIME DURING THE CONSTRUCTION OF THIS PROJECT SHALL THE CONTRACTOR ALLOW TRAFFIC TO DRIVE ON A GRAVEL SURFACE FOR MORE THEN FIVE (5) CONSECUTIVE DAYS, UNLESS OTHERWISE APPROVED BY THE ENGINEER.
- THERE SHALL BE NO NIGHT WORK BETWEEN THE HOURS OF 7:00 PM AND 7:00 AM EXCEPT AS REQUIRED FOR UTILITY SERVICE INTERRUPTIONS AND AS APPROVED BY THE ENGINEER.
- DELINEATION WITH REFLECTORIZED PLASTIC DRUMS SHALL BE USED ALONG EMBANKMENTS, AND AT OTHER LOCATIONS WHERE EXISTING GUIDE RAIL HAS BEEN REMOVED, AND SHALL REMAIN IN PLACE UNTIL SATISFACTORY PROTECTION HAS BEEN PROVIDED. SPACING OF DRUMS SHALL BE CONSISTENT WITH THE CONTRACT DOCUMENTS AND AS DIRECTED BY THE ENGINEER.
- THE CONTRACTOR SHALL MAINTAIN STABLE EXCAVATION SIDE SLOPES AT ALL TIMES.
- IT IS THE CONTRACTOR'S RESPONSIBILITY TO COORDINATE WITH ALL PUBLIC AND PRIVATE UTILITIES FOR MAINTENANCE OR RELOCATION WORK WITH RESPECT TO SITE ACCESS, TRAFFIC CONTROL AND SCHEDULING TO AVOID CONFLICTS FOR TIMELY COMPLETION OF THE WORK.
- THE CONTRACTOR SHALL PROVIDE SAFE AND CONVENIENT EMERGENCY ACCESS FOR LOCAL FIRE, POLICE AUTHORITIES AND AMBULANCE SERVICES THROUGHOUT THE PROJECT AREA AT ALL TIMES.
- RESPONSIBILITY FOR EMERGENCY REPAIRS: THE CONTRACTOR SHALL, IN WRITING, SUBMIT TO THE APPROPRIATE LAW ENFORCEMENT AND GOVERNMENT AGENCIES THE NAME, ADDRESS AND TELEPHONE NUMBER(S) OF THE PERSON OR PERSONS AUTHORIZED TO SECURE LABOR, MATERIALS AND EQUIPMENT FOR EMERGENCY REPAIRS OUTSIDE OF NORMAL WORKING HOURS. DUPLICATE COPIES OF THE ABOVE SHALL BE FILED WITH THE ENGINEER.
- WHERE DRUMS, CONES, VERTICAL PANELS OR TUBULAR MARKERS ARE USED IN CONTROLLING THE MOVEMENT OF TRAFFIC, THE CONTRACTOR SHALL TAKE WHATEVER STEPS ARE NECESSARY TO PREVENT ALL TRAFFIC CONTROL DEVICES FROM BEING BLOWN OVER OR DISPLACED BY PASSING VEHICLES. THE CONTRACTOR SHALL ACCOMPLISH THIS BY DOUBLING CONES, THE USE OF SAND BAGS, RINGS OR BY OTHER MEANS, AS APPROVED BY THE ENGINEER, WHICH SHALL NOT PRESENT A HAZARD TO MOTORISTS OR WORKERS IF THE CONES, DRUMS, VERTICAL PANELS OR TUBULAR MARKERS ARE STRUCK.
- THE CONTRACTOR SHALL BACKFILL ALL OPEN EXCAVATIONS OR PROVIDE ANCHORED STEEL PLATES TO COVER ALL TRENCH EXCAVATIONS DURING NON-WORKING HOURS. ANCHORED STEEL PLATES SHALL ALSO BE PLACED ON SUBGRADE, SUBBASE COURSES OR BASE COURSES TO PROTECT SHALLOW UTILITY FACILITIES FROM WHEEL LOADINGS DUE TO CONSTRUCTION VEHICLES AND EQUIPMENT. STEEL PLATES SHALL BE RAMPED WITH ASPHALT IN THE ROADWAY AREA TO PROVIDE A SMOOTH TRANSITION. THE COST FOR ANCHORED PLATES AND PAVEMENT SHALL BE INCLUDED IN THE PRICE BID FOR ITEM 619.01.
- TRAVEL LANE WIDTH SHALL BE 10'-0" MINIMUM AT ALL TIMES UNLESS OTHERWISE DIRECTED BY THE ENGINEER.
- THE BARRICADE SHALL NOT BE PLACED ALONG THE MERGING TAPER. THE LANE SHALL BE CLOSED USING CHANNELIZING DEVICES AND PAVEMENT MARKINGS.
- ANY EXISTING PAVEMENT MARKINGS THAT ARE CONFLICTING OR MISLEADING SHALL BE REMOVED OR COVERED.
- ADJUSTMENTS IN THE LOCATION OF ADVANCED WARNING SIGNS SHALL BE MADE TO ACCOMMODATE THE HORIZONTAL AND VERTICAL ALIGNMENT OF THE ROADWAY, RECOGNIZING THAT THE DISTANCES SHOWN FOR SIGN SPACING ARE MINIMUM. ADJUSTMENTS IN THE HEIGHT OF THE SIGNAL HEADS SHALL BE MADE AS NEEDED TO CONFORM TO THE VERTICAL ALIGNMENT.

SINGLE LANE OPERATIONS


- STAGED CONSTRUCTION METHODS WILL BE UTILIZED TO MAINTAIN ONE LANE OF TRAFFIC AT ALL TIMES.
- THE CONTRACTOR SHALL NOTIFY THE TOWN OF TICONDEROGA AND ESSEX COUNTY IN WRITING A MINIMUM OF 14 CALENDAR DAYS IN ADVANCE AS TO WHEN HE WISHES TO UTILIZE THE TEMPORARY TRAFFIC SIGNALS AND REDUCE THE ROADWAY TO ONE LANE OPERATIONS. ONE LANE OPERATIONS MUST ONLY BE UTILIZED FOR THE TIME FRAMES AS OUTLINED IN THE SPECIAL NOTES "CULVERT OPENING" AND CONFORM TO ALL SPECIAL PROVISIONS AS OUTLINED IN THE PROJECT MANUAL. THE COST OF ALL SIGNAGE AND MAINTENANCE OF THE ONE LANE OPERATIONS SHALL BE INCLUDE UNDER ITEM 619.01 - BASIC WORK ZONE TRAFFIC CONTROL.

CULVERT OPENING

- VETERAN'S ROAD AND CULVERT APPROACHES MUST BE COMPLETED IN ACCORDANCE WITH THE PROJECT MANUAL. IN THE EVENT WORK IS NOT COMPLETED TO A POINT WHERE VETERAN'S ROAD IS NOT OPENED TO TRAFFIC, LIQUIDATED DAMAGES SHALL BE ACCESSED TO THE CONTRACTOR PER TABLE 108-1 OF THE STANDARD SPECIFICATIONS.
- PRIOR TO OPENING, THE NEW CULVERT AND APPROACHES MUST BE COMPLETED TO THE EXTENT THAT PUBLIC TRAFFIC CAN BE SAFELY ACCOMMODATED. THIS INCLUDES ALL STRUCTURAL ELEMENTS, PAVEMENT UP TO TOP COURSE, PAVEMENT MARKINGS AND TRAFFIC SIGNS.
- THE CONTRACTOR AGREES IN UNDERTAKING THIS PROJECT THAT ALL CONSIDERATIONS HAVE BEEN TAKEN AND ALLOWANCES MADE FOR ALL ORDINARY DELAYS AND HINDRANCES TO SUCH WORK, SUCH AS WEATHER, SECURING MATERIALS AND LABOR, AND CONDITIONS OR RESTRICTIONS AT THE PROJECT SITE.

PROJECT MANAGER: S. KERN
 CHECK: S. KERN
 DRAFTING: F. CUCCIO
 CHECK: B. WEAVER
 DESIGN: S. KERN
 JOB MANAGER: D. THOMAS
 DESIGN SUPERVISOR: J. SIMKULET

AFFIX SEAL: GREENMAN - PEDERSEN, INC ON: APRIL 15, 2021	ALTERED BY: ON:
	

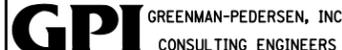AS-BUILT REVISIONS DESCRIPTION OF ALTERATIONS:	VETERAN'S ROAD CULVERT REPLACEMENT OVER FIVE MILE CREEK TOWN OF TICONDEROGA COUNTY: ESSEX REGION: 1	PIN 1761.09	BRIDGES	CULVERTS	ALL DIMENSIONS IN ft UNLESS OTHERWISE NOTED WORK ZONE TRAFFIC CONTROL GENERAL NOTES	CONTRACT NUMBER D036296 DRAWING NO. WZT-1 SHEET NO. 7
IT IS A VIOLATION OF LAW FOR ANY PERSON, UNLESS THEY ARE ACTING UNDER THE DIRECTION OF A LICENSED PROFESSIONAL ENGINEER, ARCHITECT, LANDSCAPE ARCHITECT, OR LAND SURVEYOR, TO ALTER AN ITEM IN ANY WAY. IF AN ITEM BEARING THE STAMP OF A LICENSED PROFESSIONAL IS ALTERED, THE ALTERING ENGINEER, ARCHITECT, LANDSCAPE ARCHITECT, OR LAND SURVEYOR SHALL STAMP THE DOCUMENT AND INCLUDE THE NOTATION "ALTERED BY" FOLLOWED BY THEIR SIGNATURE, THE DATE OF SUCH ALTERATION, AND A SPECIFIC DESCRIPTION OF THE ALTERATION.						
						

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 DATE/TIME = 4/15/2021
 USER = skern

FILE NAME = ... \CADD\176109_CPB_WZT-2.dgn
 DATE/TIME = 4/15/2021
 USER = skern

DESIGN SUPERVISOR J. SIMKULET
 JOB MANAGER D. THOMAS
 DESIGN S. KERN
 CHECK B. WEAVER
 DRAFTING F. CIUCCIO
 CHECK S. KERN
 PROJECT MANAGER S. KERN


LEGEND

WORK ZONE 

CONSTRUCTION SIGNS (ITEM 619.01) 

LOCATION * 

TEXT * 

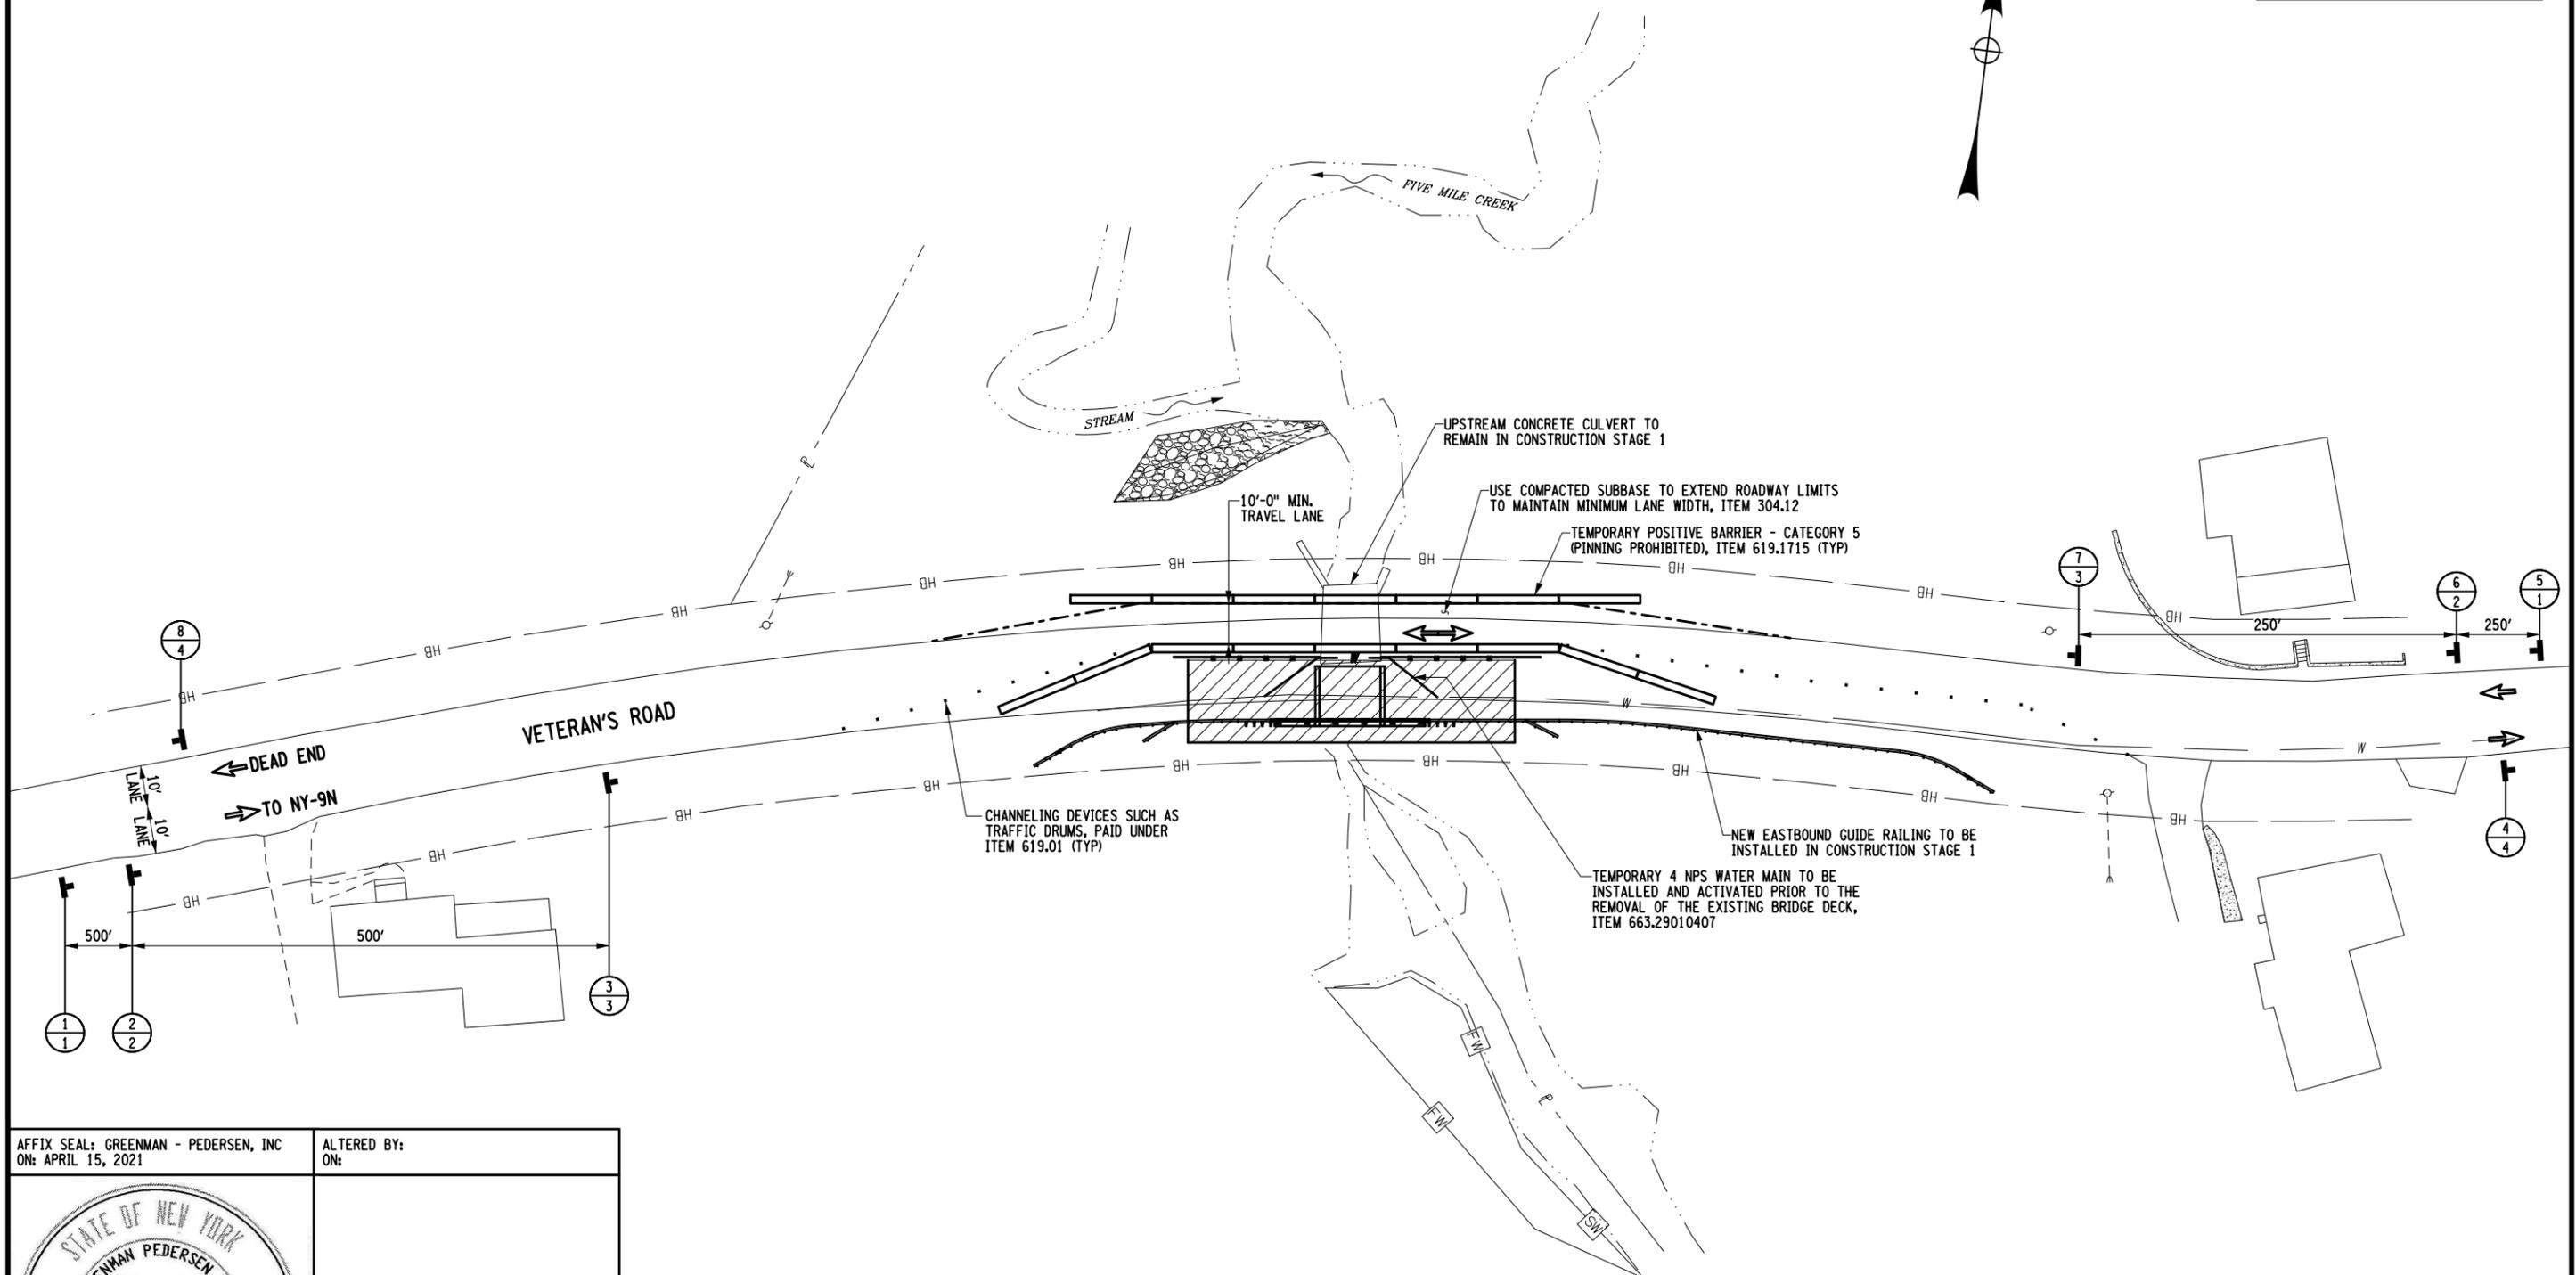


AFFIX SEAL: GREENMAN - PEDERSEN, INC
 ON: APRIL 15, 2021

ALTERED BY:
 ON:




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	OVER FIVE MILE CREEK					WORK ZONE TRAFFIC CONTROL PLAN - STAGE 1	DRAWING NO. WZT-2 SHEET NO. 8
	TOWN OF TICONDEROGA						
	COUNTY: ESSEX	REGION: 1					
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PROJECT MANAGER S. KERN
 CHECK S. KERN
 DRAFTING F. CUOCCIO
 CHECK B. WEAVER
 DESIGN S. KERN
 JOB MANAGER D. THOMAS
 DESIGN SUPERVISOR J. SIMKULET

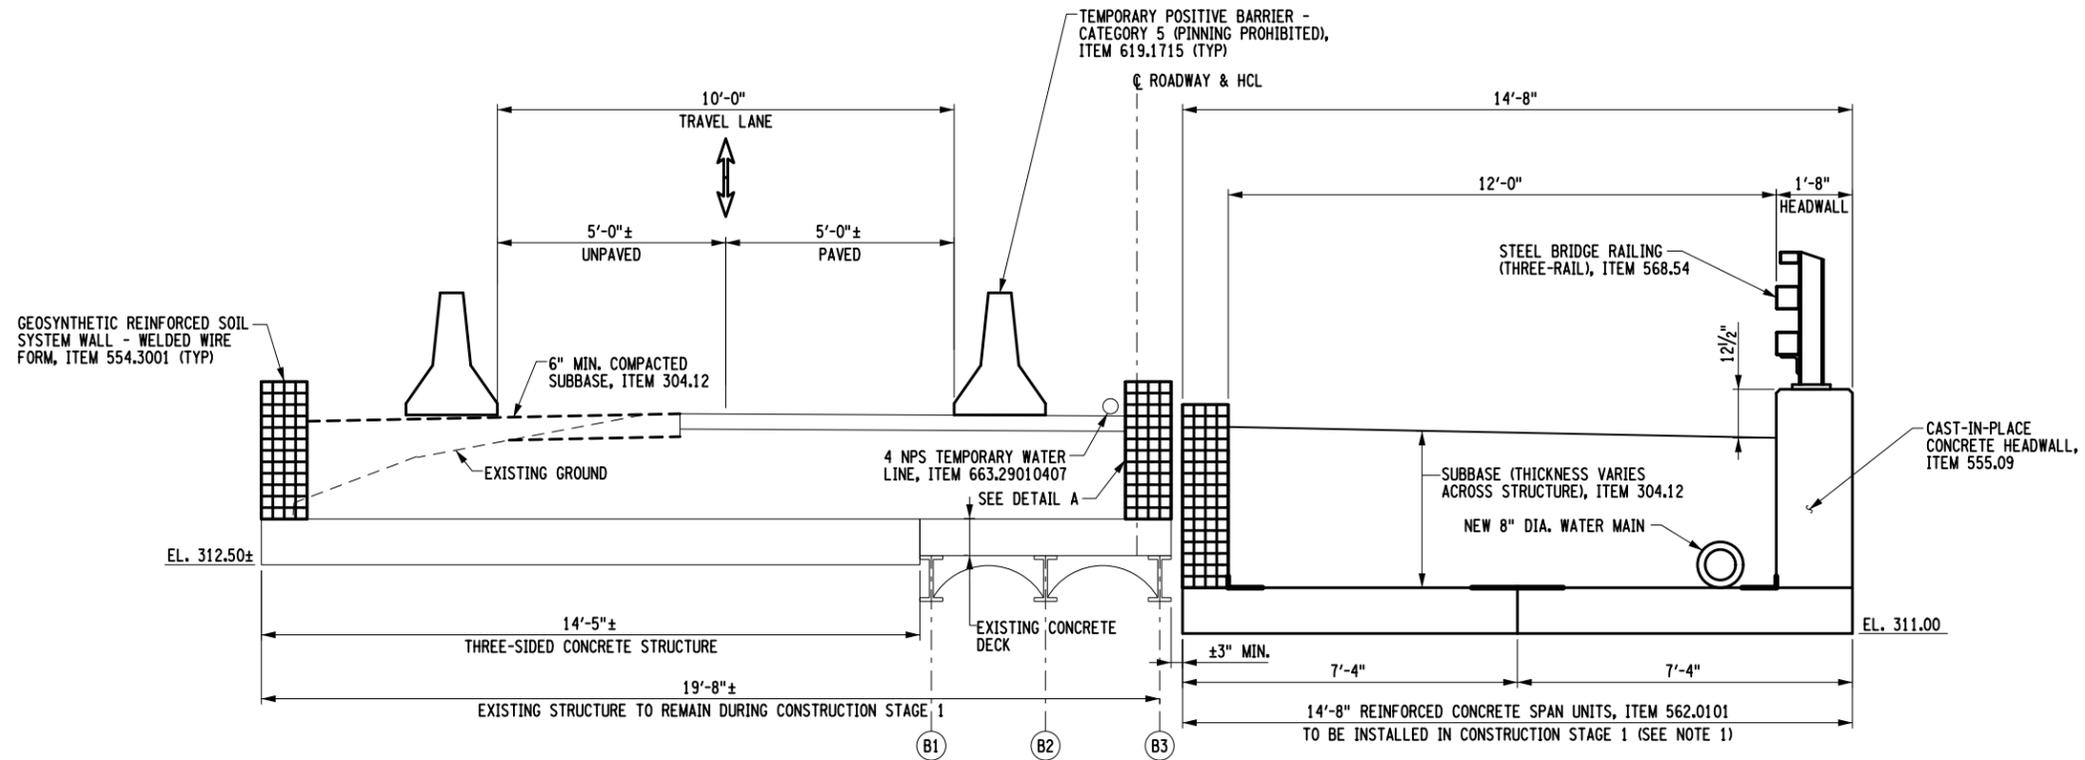


CONSTRUCTION STAGE 1 TYPICAL SECTION

SCALE: 1/4"=1'-0"

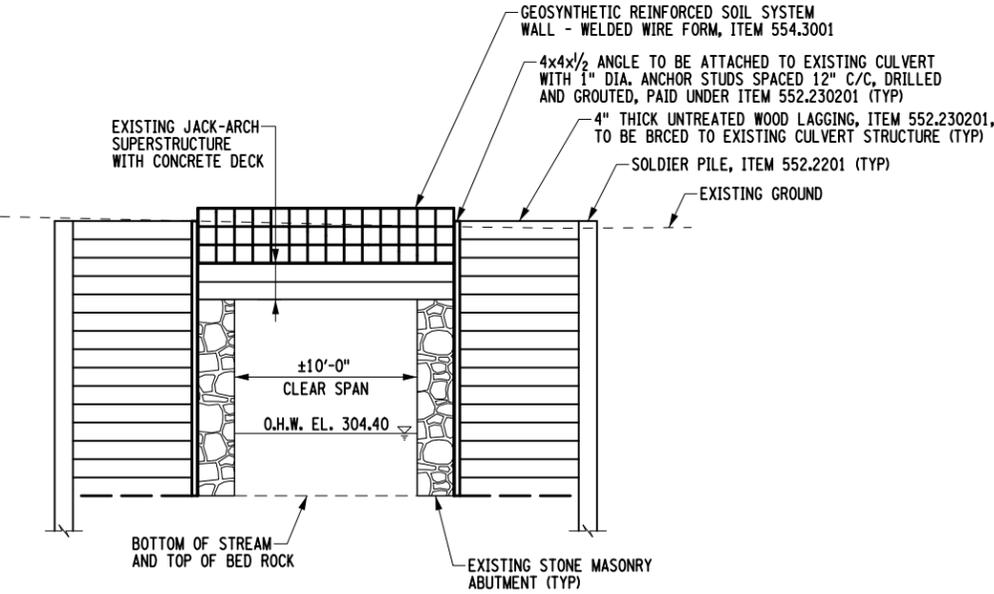

SECTION A-A

SCALE: 1"=10'

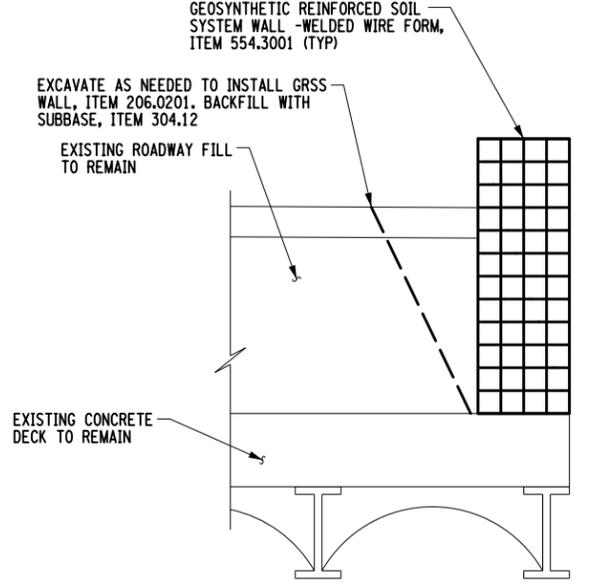

DETAIL A

SCALE: 1/2"=1'-0"

NOTES:
 1. THE NUMBER AND SIZE OF REINFORCED CONCRETE SPAN UNITS ARE ARBITRARILY SHOWN. ACTUAL NUMBER AND WIDTH OF CONCRETE UNITS SHALL BE IN ACCORDANCE WITH CONTRACTOR'S APPROVED DESIGN CALCULATIONS AND SHOP DRAWINGS.

AFFIX SEAL: GREENMAN - PEDERSEN, INC
 ON: APRIL 15, 2021
 ALTERED BY:
 ON:



AS-BUILT REVISIONS DESCRIPTION OF ALTERATIONS:	VETERAN'S ROAD CULVERT REPLACEMENT OVER FIVE MILE CREEK	PIN 1761.09	BRIDGES	CULVERTS
	TOWN OF TICONDEROGA			
	COUNTY: ESSEX	REGION: 1		

ALL DIMENSIONS IN FT UNLESS OTHERWISE NOTED	CONTRACT NUMBER D036296
WORK ZONE TRAFFIC CONTROL TYPICAL SECTION - STAGE 1	DRAWING NO. WZT-3 SHEET NO. 9

IT IS A VIOLATION OF LAW FOR ANY PERSON, UNLESS THEY ARE ACTING UNDER THE DIRECTION OF A LICENSED PROFESSIONAL ENGINEER, ARCHITECT, LANDSCAPE ARCHITECT, OR LAND SURVEYOR, TO ALTER AN ITEM IN ANY WAY. IF AN ITEM BEARING THE STAMP OF A LICENSED PROFESSIONAL IS ALTERED, THE ALTERING ENGINEER, ARCHITECT, LANDSCAPE ARCHITECT, OR LAND SURVEYOR SHALL STAMP THE DOCUMENT AND INCLUDE THE NOTATION "ALTERED BY" FOLLOWED BY THEIR SIGNATURE, THE DATE OF SUCH ALTERATION, AND A SPECIFIC DESCRIPTION OF THE ALTERATION.



FILE NAME = ...CADD\176109_CPB_WZT-3.dgn
 DATE/TIME = 4/15/2021
 USER = skern

FILE NAME = ...\\CADD\176109_CPB_WZT-4.dgn
 DATE/TIME = 4/15/2021
 USER = skern

DESIGN SUPERVISOR J. SIMKULET

JOB MANAGER D. THOMAS


DESIGN S. KERN

CHECK B. WEAVER

DRAFTING F. CIUCCIO

CHECK S. KERN

PROJECT MANAGER S. KERN

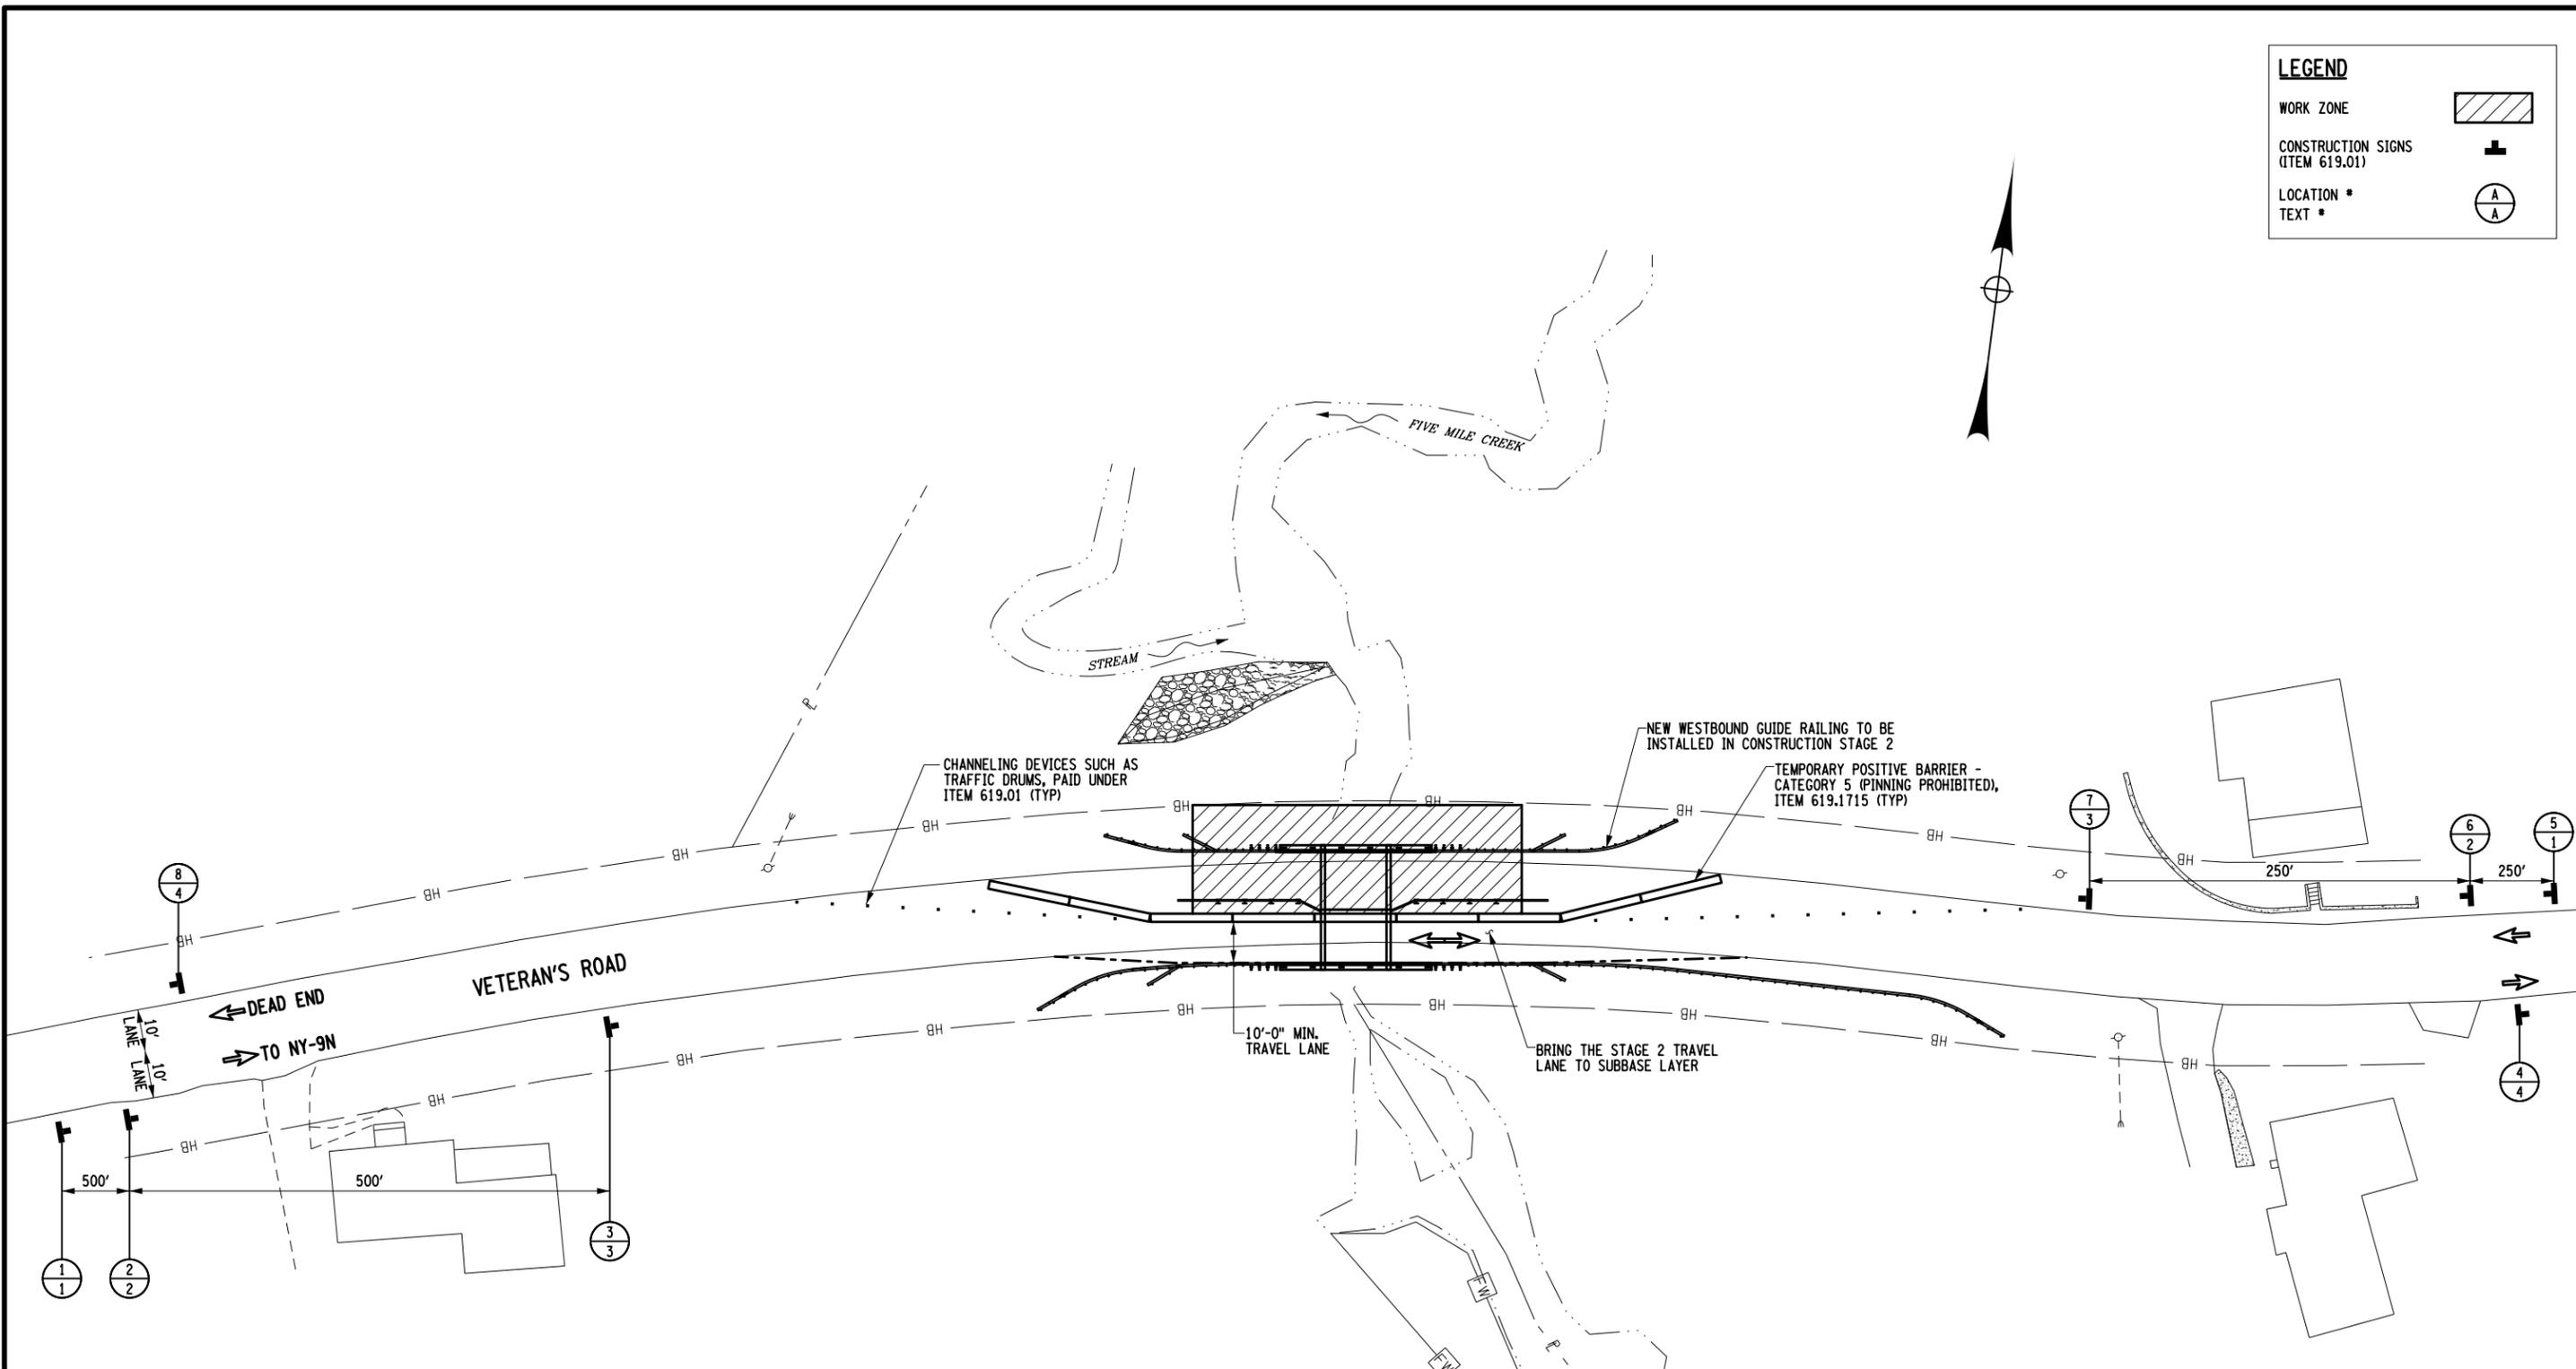

LEGEND

WORK ZONE

CONSTRUCTION SIGNS (ITEM 619.01)

LOCATION *

TEXT *



AFFIX SEAL: GREENMAN - PEDERSEN, INC
 ON: APRIL 15, 2021

ALTERED BY:
 ON:



AS-BUILT REVISIONS DESCRIPTION OF ALTERATIONS:	VETERAN'S ROAD CULVERT REPLACEMENT	PIN 1761.09	BRIDGES	CULVERTS	ALL DIMENSIONS IN ft UNLESS OTHERWISE NOTED	CONTRACT NUMBER D036296
	OVER FIVE MILE CREEK					WORK ZONE TRAFFIC CONTROL PLAN - STAGE 2
	TOWN OF TICONDEROGA	REGION: 1				


IT IS A VIOLATION OF LAW FOR ANY PERSON, UNLESS THEY ARE ACTING UNDER THE DIRECTION OF A LICENSED PROFESSIONAL ENGINEER, ARCHITECT, LANDSCAPE ARCHITECT, OR LAND SURVEYOR, TO ALTER AN ITEM IN ANY WAY. IF AN ITEM BEARING THE STAMP OF A LICENSED PROFESSIONAL IS ALTERED, THE ALTERING ENGINEER, ARCHITECT, LANDSCAPE ARCHITECT, OR LAND SURVEYOR SHALL STAMP THE DOCUMENT AND INCLUDE THE NOTATION "ALTERED BY" FOLLOWED BY THEIR SIGNATURE, THE DATE OF SUCH ALTERATION, AND A SPECIFIC DESCRIPTION OF THE ALTERATION.

GPI GREENMAN-PEDERSEN, INC. CONSULTING ENGINEERS

TOWN OF TICONDEROGA

FILE NAME = ... \CADD\176109_CPB_WZT-5.dgn
 DATE/TIME = 4/15/2021
 USER = skern

DESIGN SUPERVISOR J. SIMKULET
 JOB MANAGER D. THOMAS
 DESIGN S. KERN
 CHECK B. WEAVER
 DRAFTING F. CIUCCIO
 CHECK S. KERN
 PROJECT MANAGER S. KERN

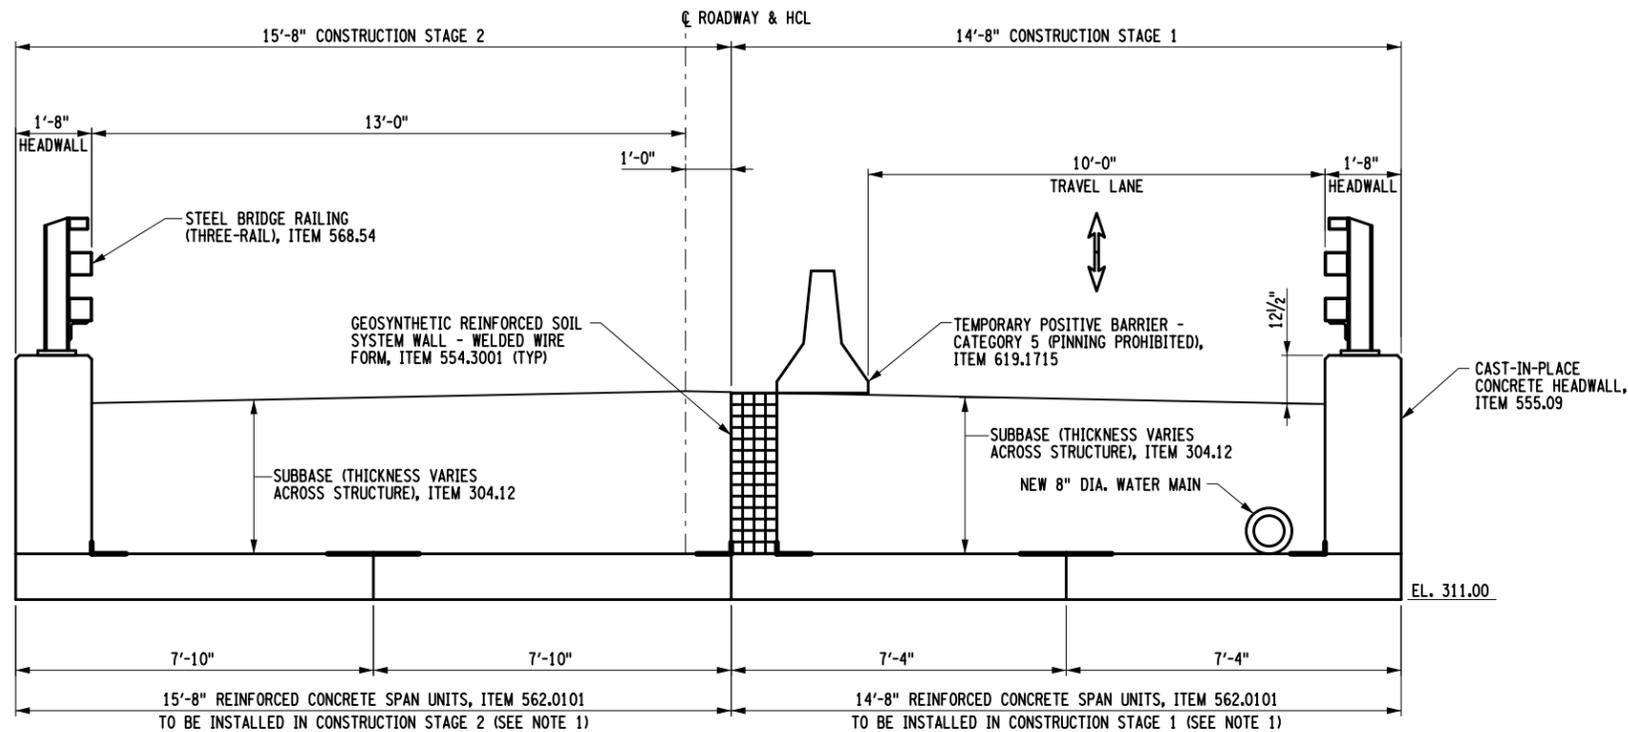

CONSTRUCTION STAGE 2 TYPICAL SECTION
 SCALE: 1/4"=1'-0"

NOTES:


1. THE NUMBER AND SIZE OF REINFORCED CONCRETE SPAN UNITS ARE ARBITRARILY SHOWN. ACTUAL NUMBER AND WIDTH OF CONCRETE UNITS SHALL BE IN ACCORDANCE WITH CONTRACTOR'S APPROVED DESIGN CALCULATIONS AND SHOP DRAWINGS.

AFFIX SEAL: GREENMAN - PEDERSEN, INC
 ON: APRIL 15, 2021
 ALTERED BY:
 ON:



AS-BUILT REVISIONS DESCRIPTION OF ALTERATIONS:	VETERAN'S ROAD CULVERT REPLACEMENT	PIN 1761.09	BRIDGES	CULVERTS	ALL DIMENSIONS IN FT UNLESS OTHERWISE NOTED	CONTRACT NUMBER D036296
	OVER FIVE MILE CREEK					DRAWING NO. WZT-5 SHEET NO. 11
	TOWN OF TICONDEROGA				WORK ZONE TRAFFIC CONTROL TYPICAL SECTION - STAGE 2	
	COUNTY: ESSEX REGION: 1					
IT IS A VIOLATION OF LAW FOR ANY PERSON, UNLESS THEY ARE ACTING UNDER THE DIRECTION OF A LICENSED PROFESSIONAL ENGINEER, ARCHITECT, LANDSCAPE ARCHITECT, OR LAND SURVEYOR, TO ALTER AN ITEM IN ANY WAY. IF AN ITEM BEARING THE STAMP OF A LICENSED PROFESSIONAL IS ALTERED, THE ALTERING ENGINEER, ARCHITECT, LANDSCAPE ARCHITECT, OR LAND SURVEYOR SHALL STAMP THE DOCUMENT AND INCLUDE THE NOTATION "ALTERED BY" FOLLOWED BY THEIR SIGNATURE, THE DATE OF SUCH ALTERATION, AND A SPECIFIC DESCRIPTION OF THE ALTERATION.						GREENMAN-PEDERSEN, INC. CONSULTING ENGINEERS TOWN OF TICONDEROGA

DETOUR CONSTRUCTION SIGNS

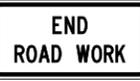TEXT NUMBER	LOCATION NUMBER	TEXT	NATIONAL OR STATE M.U.T.C.D. NUMBER
1	1, 5		W20-1
2	2, 6	 	W20-4 W8-3
3 (SEE NOTE 2)	3, 7	 	R1-2 R1-2aP
4	4, 8		G20-2

NOTES:

1. ALL DETOUR SIGNS PAID FOR UNDER ITEM 619.01.
2. SIGNS 3 AND 7 ARE TO INCLUDE A FLASHING BEACON FOR VISIBILITY, PAID UNDER ITEM 619.01.

PROJECT MANAGER S. KERN

CHECK S. KERN

DRAFTING F. CIUCCIO

CHECK B. WEAVER

DESIGN S. KERN

JOB MANAGER D. THOMAS

DESIGN SUPERVISOR J. SIMKULET

AFFIX SEAL: GREENMAN - PEDERSEN, INC
ON: APRIL 15, 2021

ALTERED BY:
ON:



AS-BUILT REVISIONS
DESCRIPTION OF ALTERATIONS:

VETERAN'S ROAD CULVERT REPLACEMENT	PIN 1761.09	BRIDGES	CULVERTS
OVER FIVE MILE CREEK			
TOWN OF TICONDEROGA			
COUNTY: ESSEX	REGION: 1		

ALL DIMENSIONS IN ft UNLESS OTHERWISE NOTED

WORK ZONE TRAFFIC CONTROL
SIGN TABLE

CONTRACT NUMBER
D036296

DRAWING NO. WZT-6
SHEET NO. 12


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GPI GREENMAN-PEDERSEN, INC. CONSULTING ENGINEERS		TOWN OF TICONDEROGA
--	---	---------------------

PROJECT MANAGER: S. KERN
 CHECK: S. KERN
 DRAFTING: F. CUOCCIO
 CHECK: B. WEAVER
 DESIGN: S. KERN
 JOB MANAGER: D. THOMAS
 DESIGN SUPERVISOR: J. SIMKULET

HORIZONTAL CONTROL AND CURVE TABLE								
H.C.L. POINT	H.C.L. STATION	NORTHING	EASTING	RADIUS	DELTA	AZIMUTH	LENGTH	TANGENT
VETERAN'S ROAD								
POB	1+00.00	1840366.6896	768028.6757					
PC	2+06.87	1840398.6829	768130.6393			72°34'46.53"	106.87'	
PC	2+06.87	1840398.6829	768130.6393	1200.00'	10°03'17.13"	RIGHT	210.59'	105.56'
PI	3+12.43	1840430.2868	768231.3617					
PT	4+17.45	1840443.8203	768336.0548					
PT	4+17.45	1840443.8203	768336.0548			82°38'03.66"	17.92'	
PC	4+35.37	1840446.1179	768353.8288					
PC	4+35.37	1840446.1179	768353.8288	800.00'	6°45'30.86"	RIGHT	94.37'	47.24'
PI	4+82.61	1840452.1739	768400.6775					
PT	5+29.74	1840452.6744	768447.9134					

HORIZONTAL CONTROL AND CURVE TABLE								
H.C.L. POINT	H.C.L. STATION	NORTHING	EASTING	RADIUS	DELTA	AZIMUTH	LENGTH	TANGENT
VETERAN'S ROAD CONTINUED								
PT	5+29.74	1840452.6744	768447.9134			89°23'34.52"	45.28'	
PC	5+75.02	1840453.1542	768493.1889					
PC	5+75.02	1840453.1542	768493.1889	500.00'	7°56'16.60"	LEFT	69.27'	34.69'
PI	6+09.71	1840453.5217	768527.8783					
PT	6+44.29	1840458.6764	768562.1845					
PT	6+44.29	1840458.6764	768562.1845			81°27'17.92"	24.22'	
POE	6+68.51	1840462.2755	768586.1380					

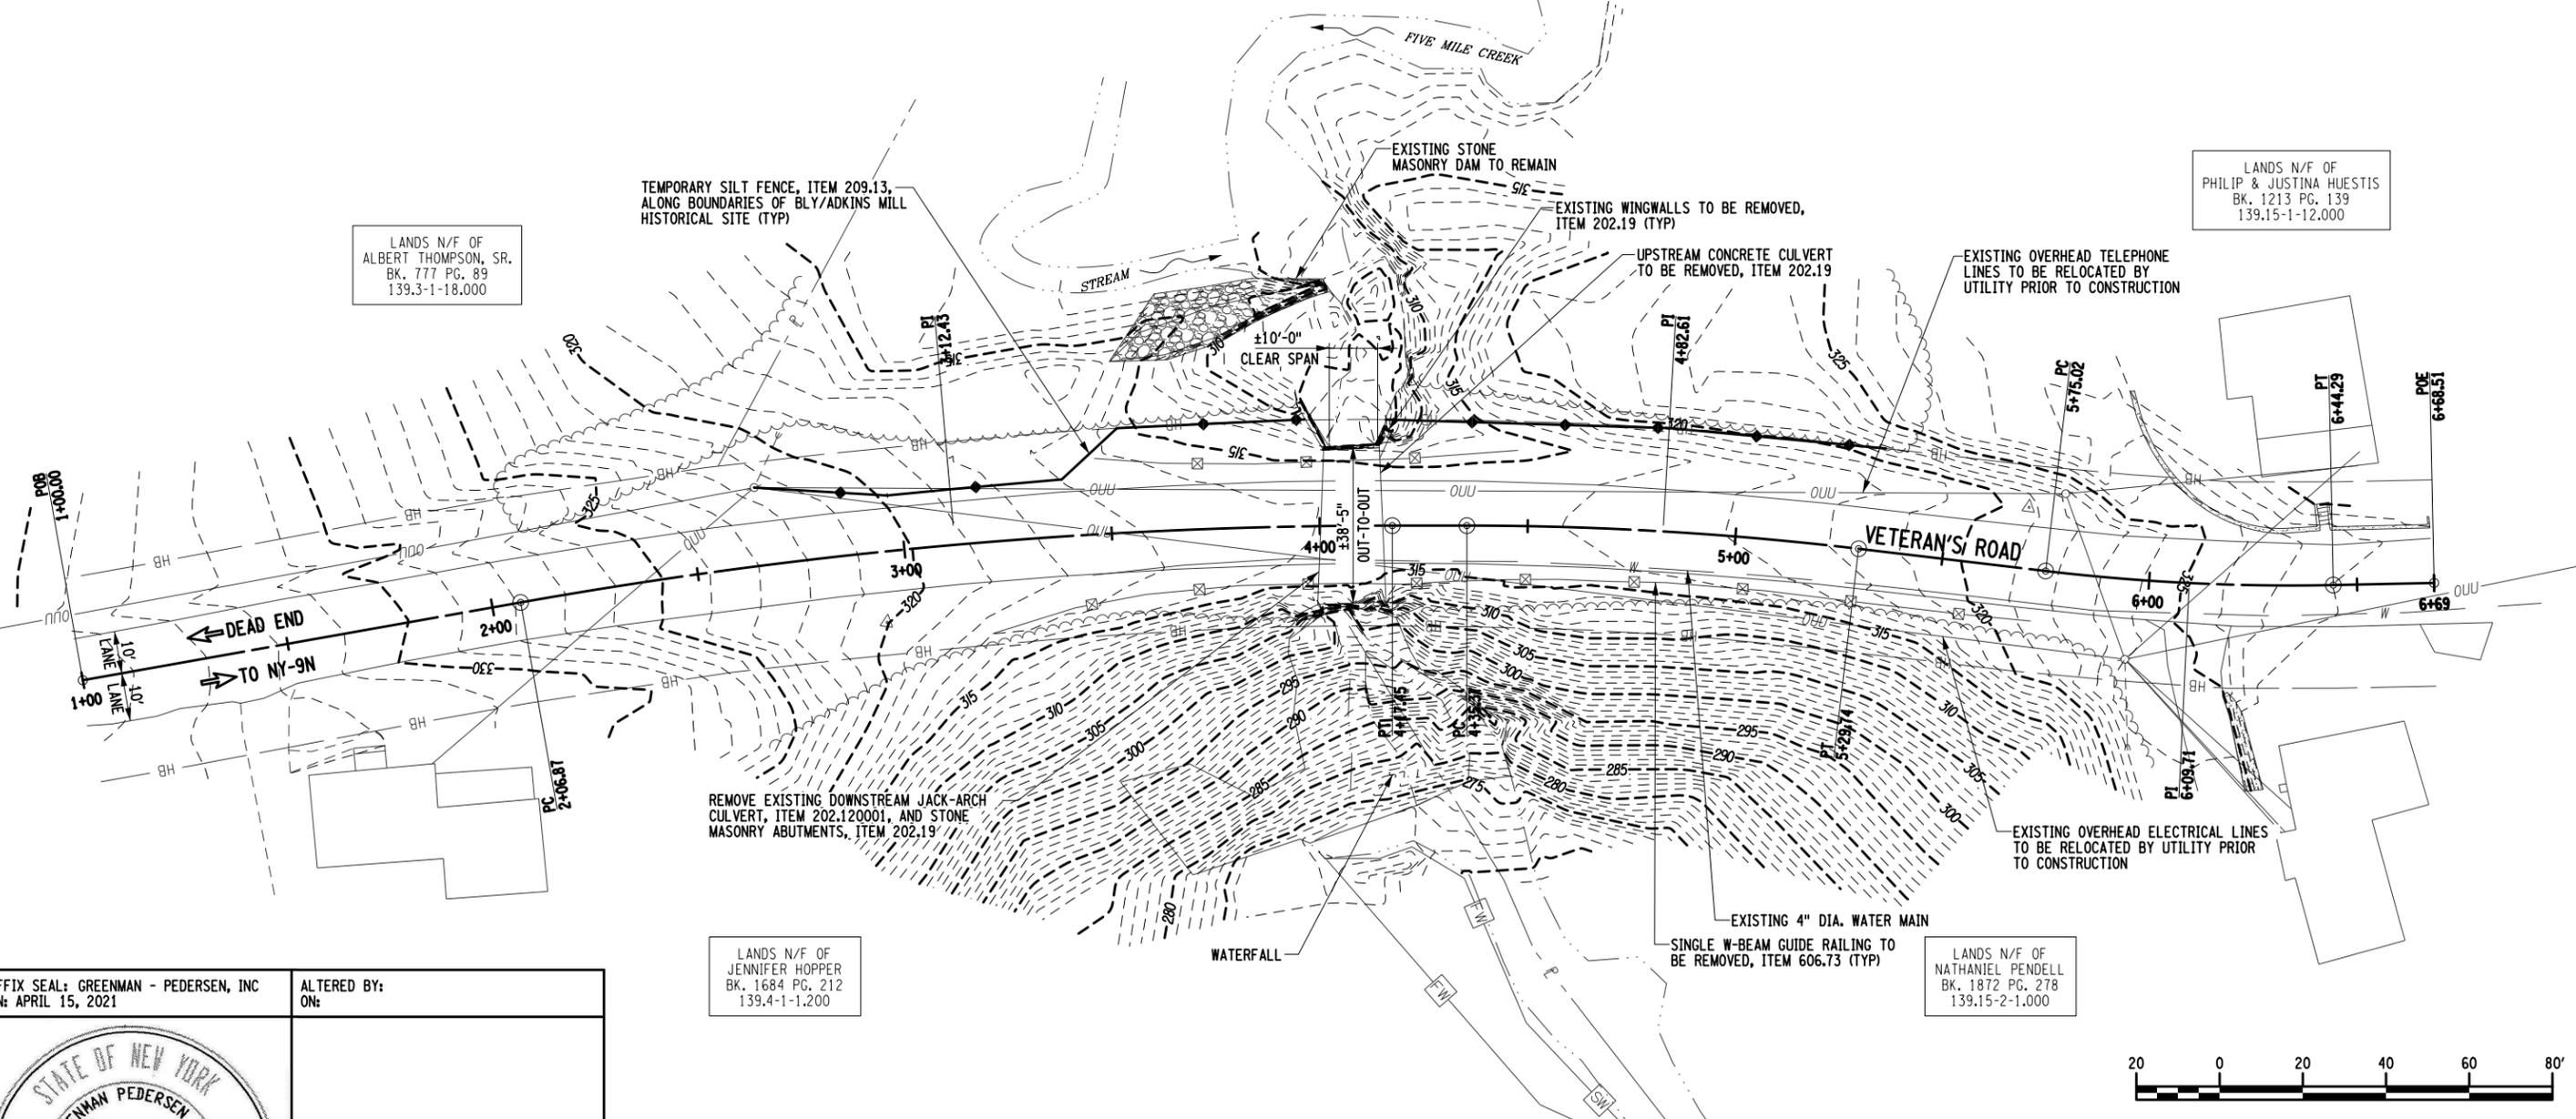

LANDS N/F OF PHILIP & JUSTINA HUESTIS BK. 1213 PG. 139 139.15-1-12.000

LANDS N/F OF ALBERT THOMPSON, SR. BK. 777 PG. 89 139.3-1-18.000

LANDS N/F OF JENNIFER HOPPER BK. 1684 PG. 212 139.4-1-1.200

LANDS N/F OF NATHANIEL PENDELL BK. 1872 PG. 278 139.15-2-1.000



AFFIX SEAL: GREENMAN - PEDERSEN, INC
ON: APRIL 15, 2021
ALTERED BY:
ON:



AS-BUILT REVISIONS DESCRIPTION OF ALTERATIONS:	VETERAN'S ROAD CULVERT REPLACEMENT OVER FIVE MILE CREEK	PIN 1761.09	BRIDGES	CULVERTS	ALL DIMENSIONS IN FT UNLESS OTHERWISE NOTED	CONTRACT NUMBER D036296
	TOWN OF TICONDEROGA				EXISTING GENERAL PLAN	DRAWING NO. ST-1
	COUNTY: ESSEX	REGION: 1				SHEET NO. 13

IT IS A VIOLATION OF LAW FOR ANY PERSON, UNLESS THEY ARE ACTING UNDER THE DIRECTION OF A LICENSED PROFESSIONAL ENGINEER, ARCHITECT, LANDSCAPE ARCHITECT, OR LAND SURVEYOR, TO ALTER AN ITEM IN ANY WAY. IF AN ITEM BEARING THE STAMP OF A LICENSED PROFESSIONAL IS ALTERED, THE ALTERING ENGINEER, ARCHITECT, LANDSCAPE ARCHITECT, OR LAND SURVEYOR SHALL STAMP THE DOCUMENT AND INCLUDE THE NOTATION "ALTERED BY" FOLLOWED BY THEIR SIGNATURE, THE DATE OF SUCH ALTERATION, AND A SPECIFIC DESCRIPTION OF THE ALTERATION.



GPI GREENMAN-PEDERSEN, INC. CONSULTING ENGINEERS

TOWN OF TICONDEROGA


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 USER = skern

FILE NAME = \\CADD\176109_CPB_BRD_PLN.E.dgn
 DATE/TIME = 4/15/2021
 USER = skern

DESIGN SUPERVISOR: J. SIMKULET
 JOB MANAGER: D. THOMAS
 DESIGN: S. KERN
 CHECK: B. WEAVER
 DRAFTING: F. CIUCCIO
 CHECK: S. KERN
 PROJECT MANAGER: S. KERN

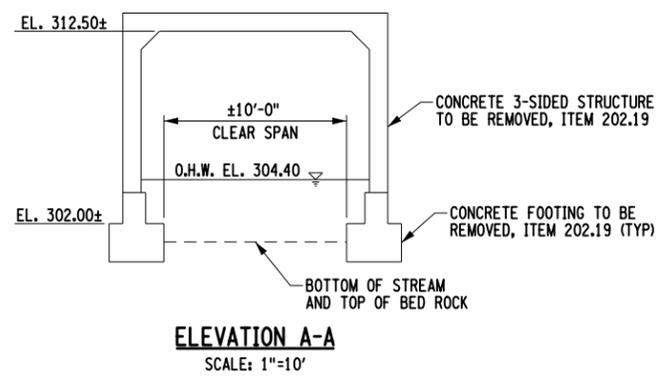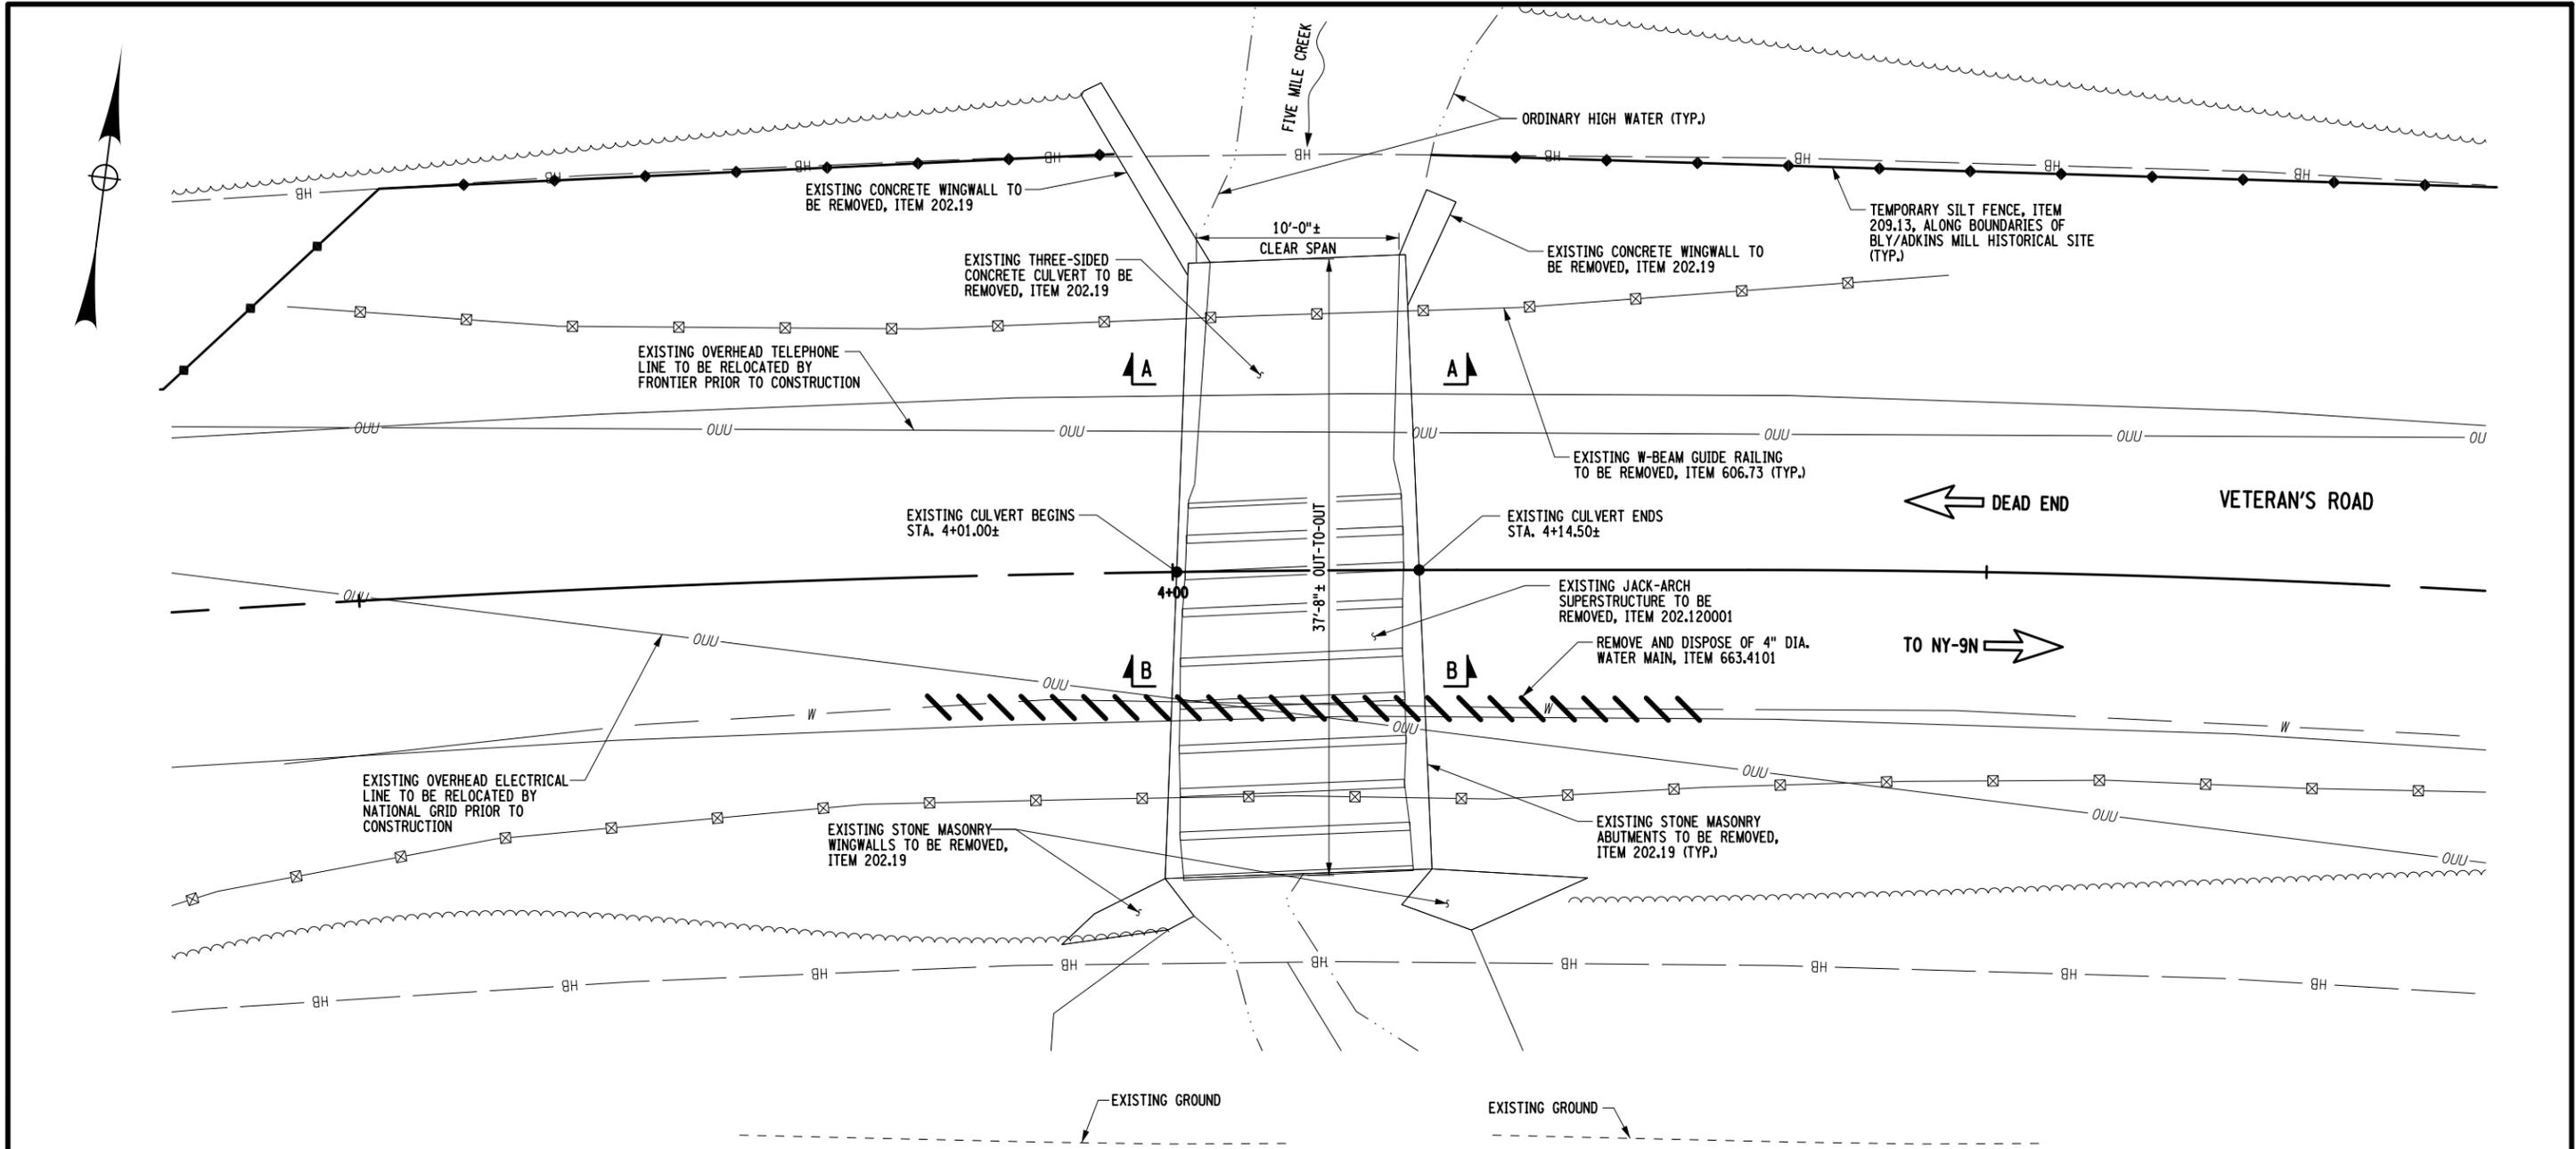

ELEVATION A-A
SCALE: 1"=10'

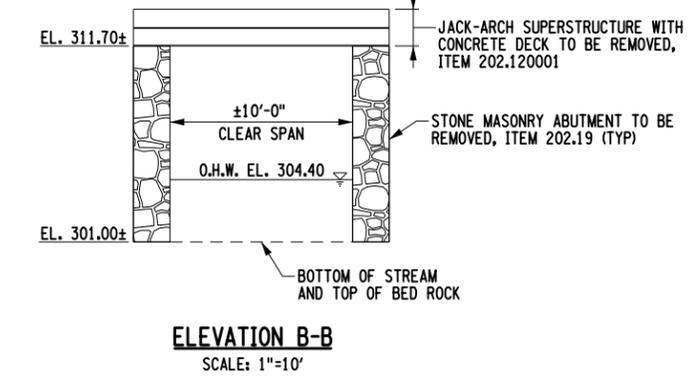

ELEVATION B-B
SCALE: 1"=10'



AFFIX SEAL: GREENMAN - PEDERSEN, INC
 ON: APRIL 15, 2021
 ALTERED BY:
 ON:




AS-BUILT REVISIONS DESCRIPTION OF ALTERATIONS:	VETERAN'S ROAD CULVERT REPLACEMENT	PIN 1761.09	BRIDGES	CULVERTS	ALL DIMENSIONS IN FT UNLESS OTHERWISE NOTED	CONTRACT NUMBER D036296
	OVER FIVE MILE CREEK				EXISTING BRIDGE PLAN	DRAWING NO. ST-2
	TOWN OF TICONDEROGA					SHEET NO. 14
	COUNTY: ESSEX	REGION: 1				

IT IS A VIOLATION OF LAW FOR ANY PERSON, UNLESS THEY ARE ACTING UNDER THE DIRECTION OF A LICENSED PROFESSIONAL ENGINEER, ARCHITECT, LANDSCAPE ARCHITECT, OR LAND SURVEYOR, TO ALTER AN ITEM IN ANY WAY. IF AN ITEM BEARING THE STAMP OF A LICENSED PROFESSIONAL IS ALTERED, THE ALTERING ENGINEER, ARCHITECT, LANDSCAPE ARCHITECT, OR LAND SURVEYOR SHALL STAMP THE DOCUMENT AND INCLUDE THE NOTATION "ALTERED BY" FOLLOWED BY THEIR SIGNATURE, THE DATE OF SUCH ALTERATION, AND A SPECIFIC DESCRIPTION OF THE ALTERATION.

GPI GREENMAN-PEDERSEN, INC. CONSULTING ENGINEERS
 TOWN OF TICONDEROGA

FILE NAME = ... \CADD\176109_CPB_TYP_SEC.E.dgn
 DATE/TIME = 4/15/2021
 USER = skern
 DESIGN SUPERVISOR J. SIMKULET
 JOB MANAGER D. THOMAS
 DESIGN S. KERN
 CHECK B. WEAVER
 DRAFTING F. CIUCCIO
 CHECK S. KERN
 PROJECT MANAGER S. KERN

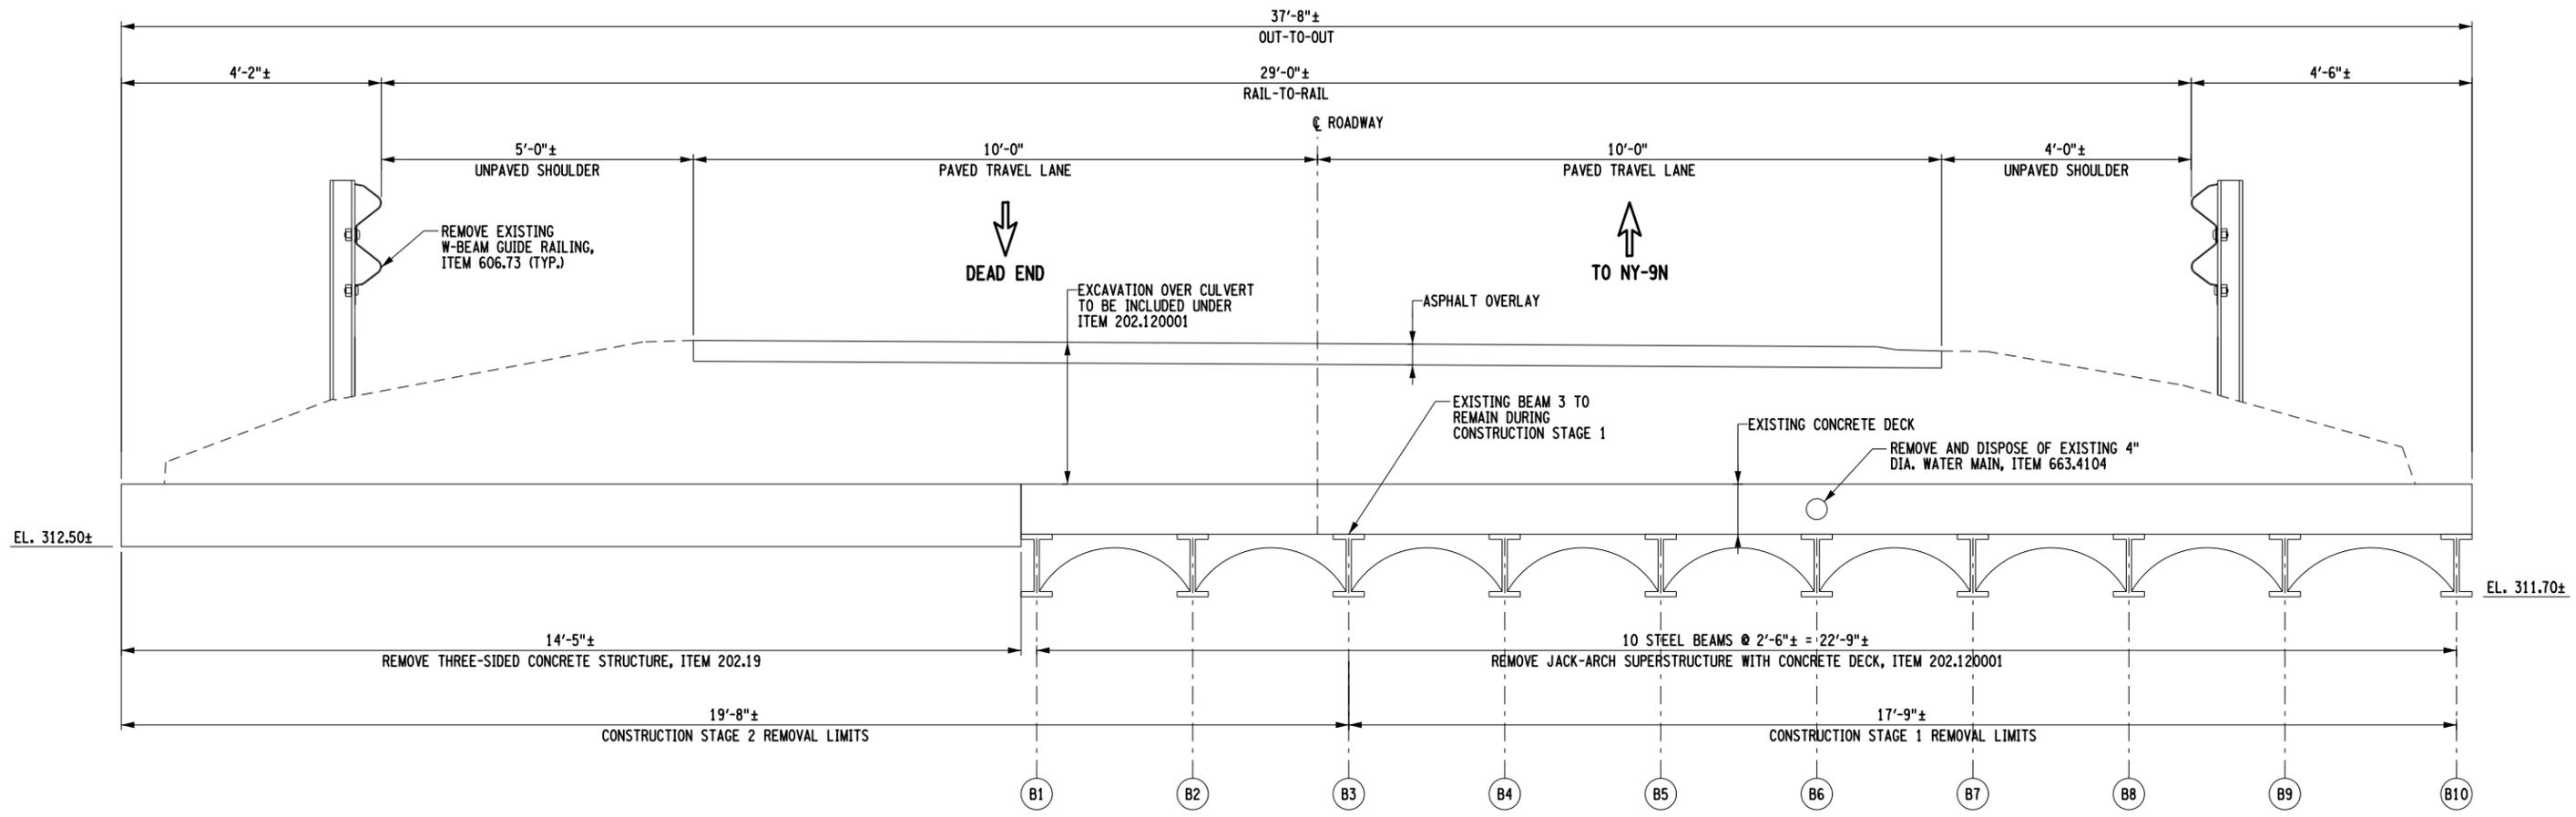

EXISTING TYPICAL SECTION
 SCALE: 3/8"=1'-0"

NOTES:
 1. EXISTING DETAILS ARE FOR ESTIMATING PURPOSES ONLY AND MAY NOT REFLECT THE ACTUAL EXISTING CONDITION.

AFFIX SEAL: GREENMAN - PEDERSEN, INC
 ON: APRIL 15, 2021
 ALTERED BY:
 ON:




AS-BUILT REVISIONS DESCRIPTION OF ALTERATIONS:	VETERAN'S ROAD CULVERT REPLACEMENT	PIN 1761.09	BRIDGES	CULVERTS	ALL DIMENSIONS IN FT UNLESS OTHERWISE NOTED	CONTRACT NUMBER D036296	
	OVER FIVE MILE CREEK					DRAWING NO. ST-3 SHEET NO. 15	
	TOWN OF TICONDEROGA				EXISTING TYPICAL SECTION		
	COUNTY: ESSEX REGION: 1						
IT IS A VIOLATION OF LAW FOR ANY PERSON, UNLESS THEY ARE ACTING UNDER THE DIRECTION OF A LICENSED PROFESSIONAL ENGINEER, ARCHITECT, LANDSCAPE ARCHITECT, OR LAND SURVEYOR, TO ALTER AN ITEM IN ANY WAY. IF AN ITEM BEARING THE STAMP OF A LICENSED PROFESSIONAL IS ALTERED, THE ALTERING ENGINEER, ARCHITECT, LANDSCAPE ARCHITECT, OR LAND SURVEYOR SHALL STAMP THE DOCUMENT AND INCLUDE THE NOTATION "ALTERED BY" FOLLOWED BY THEIR SIGNATURE, THE DATE OF SUCH ALTERATION, AND A SPECIFIC DESCRIPTION OF THE ALTERATION.						GREENMAN-PEDERSEN, INC. CONSULTING ENGINEERS	TOWN OF TICONDEROGA

FILE NAME = ...CADD\176109_CPB_GEN_PLN.P.dgn
 DATE/TIME = 4/15/2021
 USER = skern

DESIGN SUPERVISOR J. SIMKULET
 JOB MANAGER D. THOMAS
 DESIGN S. KERN
 CHECK B. WEAVER
 DRAFTING F. CIUCCIO
 CHECK S. KERN
 PROJECT MANAGER S. KERN

HORIZONTAL CONTROL AND CURVE TABLE								
H.C.L. POINT	H.C.L. STATION	NORTHING	EASTING	RADIUS	DELTA	AZIMUTH	LENGTH	TANGENT
VETERAN'S ROAD								
POB	1+00.00	1840366.6896	768028.6757					
PC	2+06.87	1840398.6829	768130.6393			72°34'46.53"	106.87'	
PC	2+06.87	1840398.6829	768130.6393	1200.00'	10°03'17.13"	RIGHT	210.59'	105.56'
PI	3+12.43	1840430.2868	768231.3617					
PT	4+17.45	1840443.8203	768336.0548					
PT	4+17.45	1840443.8203	768336.0548			82°38'03.66"	17.92'	
PC	4+35.37	1840446.1179	768353.8288					
PC	4+35.37	1840446.1179	768353.8288	800.00'	6°45'30.86"	RIGHT	94.37'	47.24'
PI	4+82.61	1840452.1739	768400.6775					
PT	5+29.74	1840452.6744	768447.9134					

HORIZONTAL CONTROL AND CURVE TABLE								
H.C.L. POINT	H.C.L. STATION	NORTHING	EASTING	RADIUS	DELTA	AZIMUTH	LENGTH	TANGENT
VETERAN'S ROAD CONTINUED								
PT	5+29.74	1840452.6744	768447.9134			89°23'34.52"	45.28'	
PC	5+75.02	1840453.1542	768493.1889					
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PT	6+44.29	1840458.6764	768562.1845					
PT	6+44.29	1840458.6764	768562.1845			81°27'17.92"	24.22'	
PC	6+68.51	1840462.2755	768586.1380					

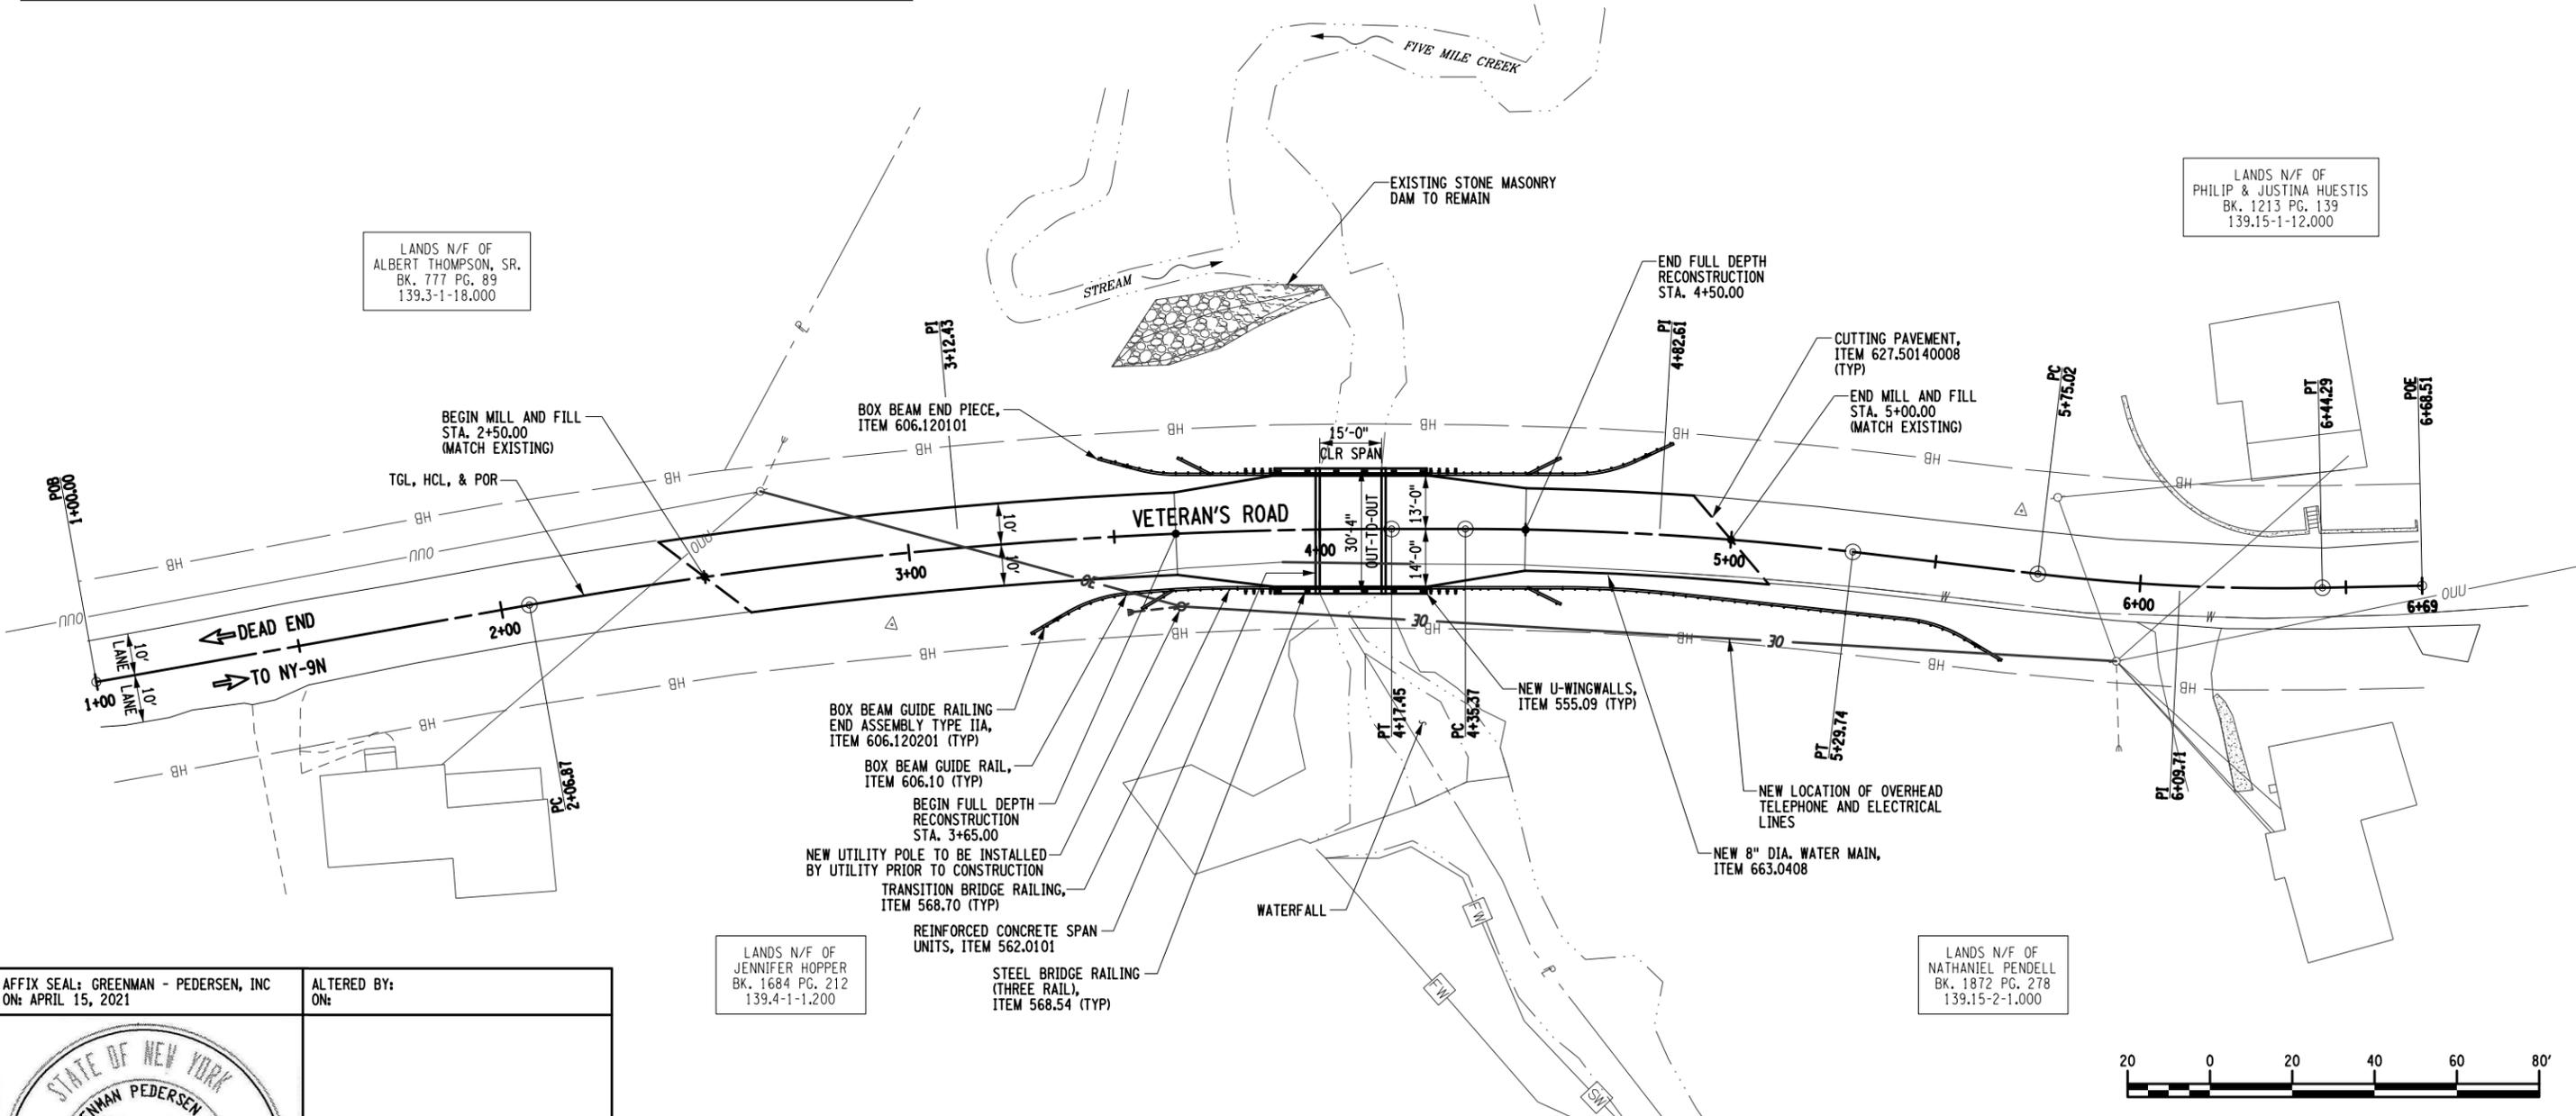

AFFIX SEAL: GREENMAN - PEDERSEN, INC
 ON: APRIL 15, 2021
 ALTERED BY:
 ON:




AS-BUILT REVISIONS DESCRIPTION OF ALTERATIONS:	VETERAN'S ROAD CULVERT REPLACEMENT OVER FIVE MILE CREEK	PIN 1761.09	BRIDGES	CULVERTS	ALL DIMENSIONS IN FT UNLESS OTHERWISE NOTED	CONTRACT NUMBER D036296
	TOWN OF TICONDEROGA				PROPOSED GENERAL PLAN	DRAWING NO. ST-4
	COUNTY: ESSEX	REGION: 1				SHEET NO. 16

IT IS A VIOLATION OF LAW FOR ANY PERSON, UNLESS THEY ARE ACTING UNDER THE DIRECTION OF A LICENSED PROFESSIONAL ENGINEER, ARCHITECT, LANDSCAPE ARCHITECT, OR LAND SURVEYOR, TO ALTER AN ITEM IN ANY WAY. IF AN ITEM BEARING THE STAMP OF A LICENSED PROFESSIONAL IS ALTERED, THE ALTERING ENGINEER, ARCHITECT, LANDSCAPE ARCHITECT, OR LAND SURVEYOR SHALL STAMP THE DOCUMENT AND INCLUDE THE NOTATION "ALTERED BY" FOLLOWED BY THEIR SIGNATURE, THE DATE OF SUCH ALTERATION, AND A SPECIFIC DESCRIPTION OF THE ALTERATION.

GPI GREENMAN-PEDERSEN, INC. CONSULTING ENGINEERS
 TOWN OF TICONDEROGA


PROJECT MANAGER S. KERN
 CHECK S. KERN
 DRAFTING F. CUOCCIO
 CHECK B. WEAVER
 DESIGN S. KERN
 JOB MANAGER D. THOMAS
 DESIGN SUPERVISOR J. SIMKULET

FILE NAME = ...CADD\176109_CPB_BRD_PLN_P.dgn
 DATE/TIME = 4/15/2021
 USER = skern

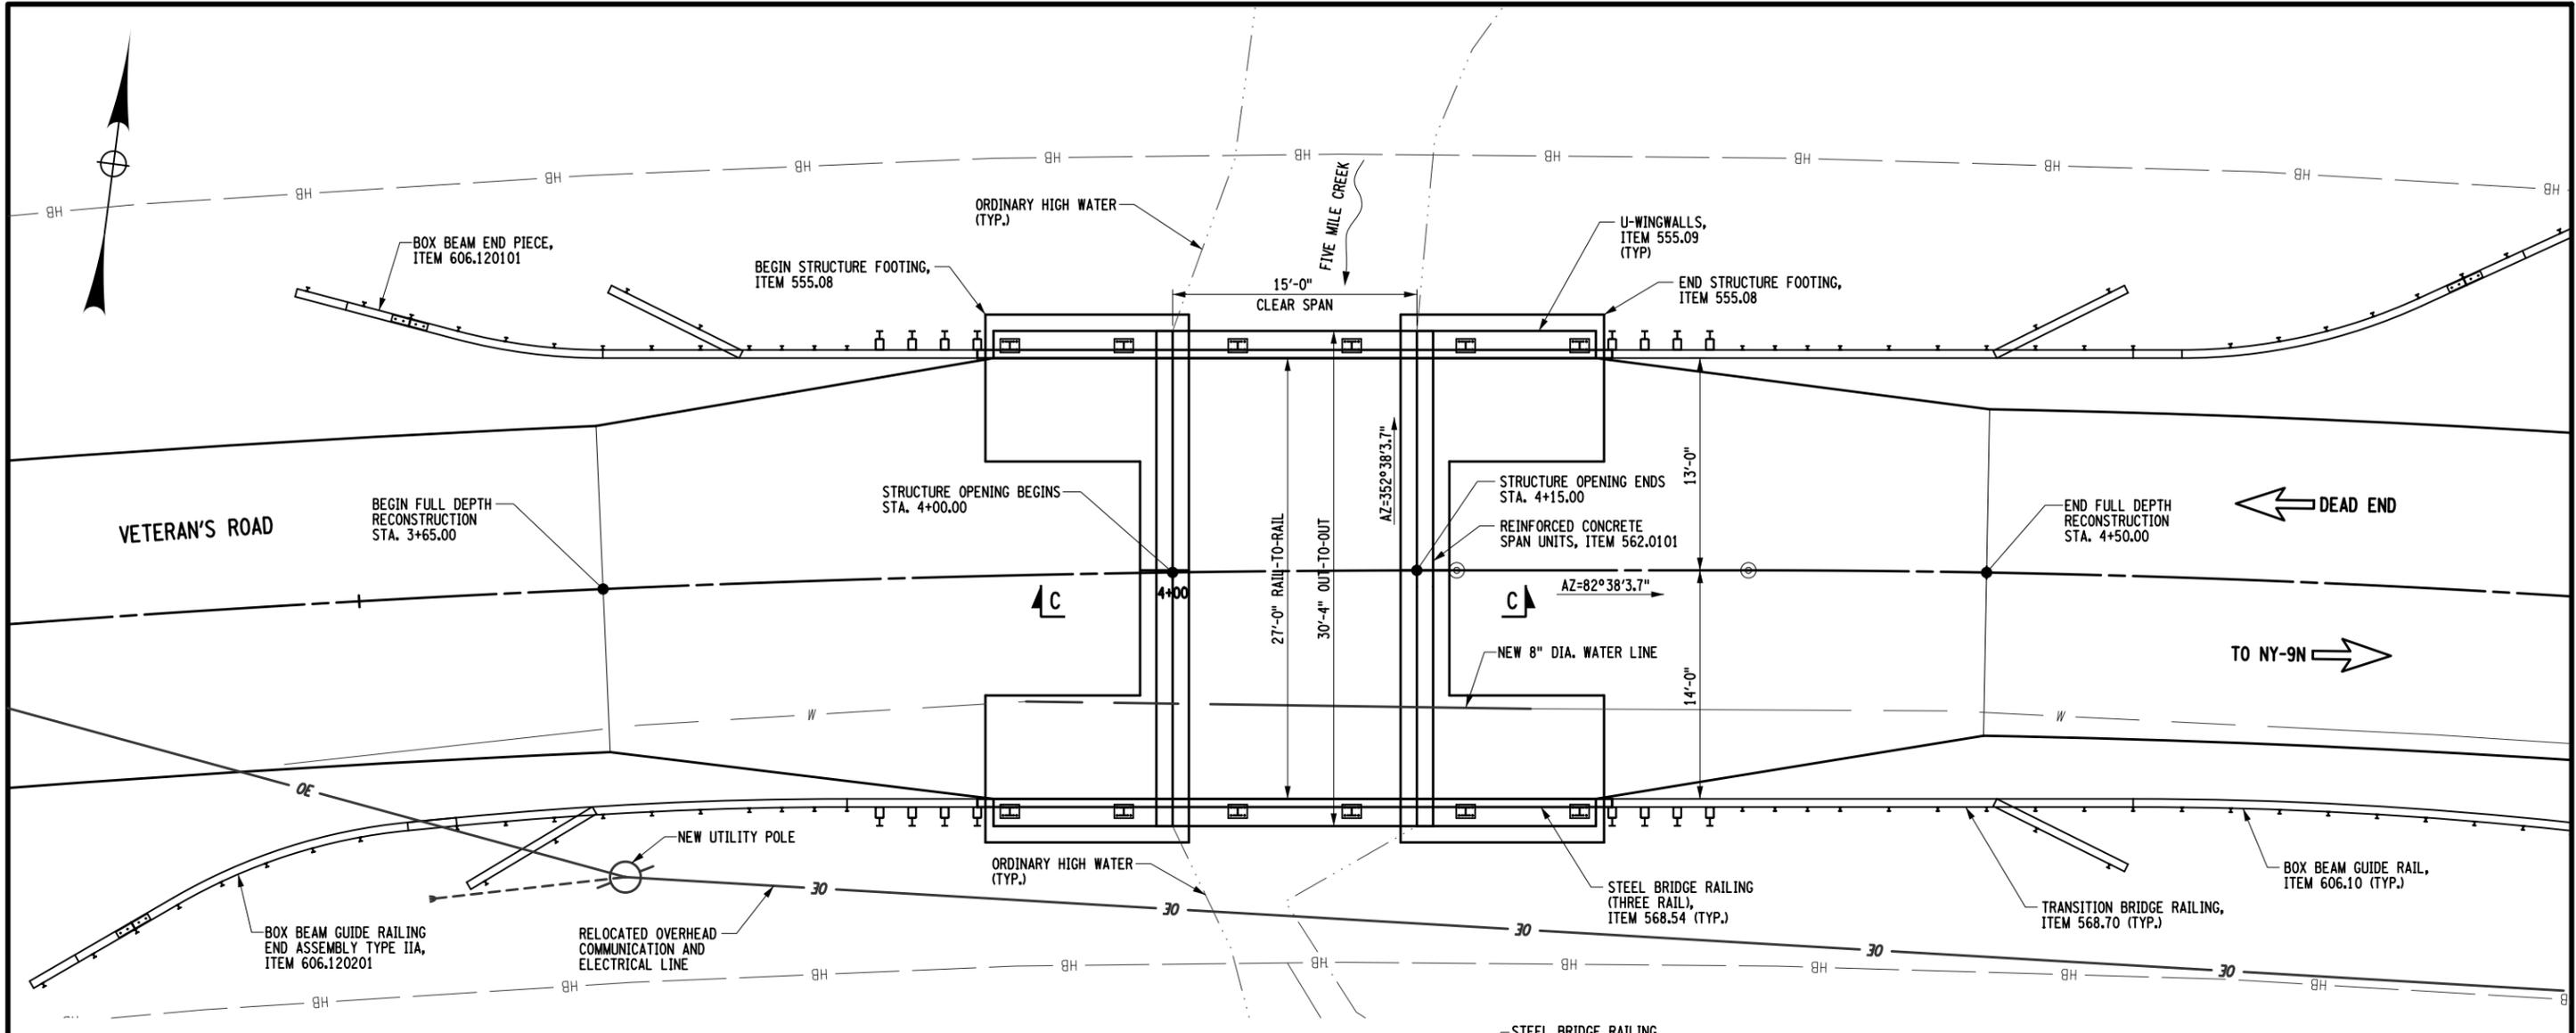

HYDRAULIC DATA TABLE			
DRAINAGE AREA =	3.34 (SQ. MILES)	BASIC FLOOD	DESIGN FLOOD
RECURRENCE INTERVAL	(YRS.) 100	50	
PEAK DISCHARGE	(FT ³ /S) 338	294	
HIGH WATER ELEVATION @ PT. OF MAX. BACKWATER	EXISTING	307.01	306.58
	PROPOSED	305.63	305.32
AVG. VELOCITY THRU STRUCTURE @ DESIGN FLOOD	(FT/S) 25.1	24.1	

NOTES
 1. 12" WALL AND CEILING THICKNESSES ARE ARBITRARILY SHOWN. ACTUAL VALUES SHALL BE IN ACCORDANCE WITH CONTRACTOR'S APPROVED DESIGN CALCULATIONS AND SHOP DRAWINGS.

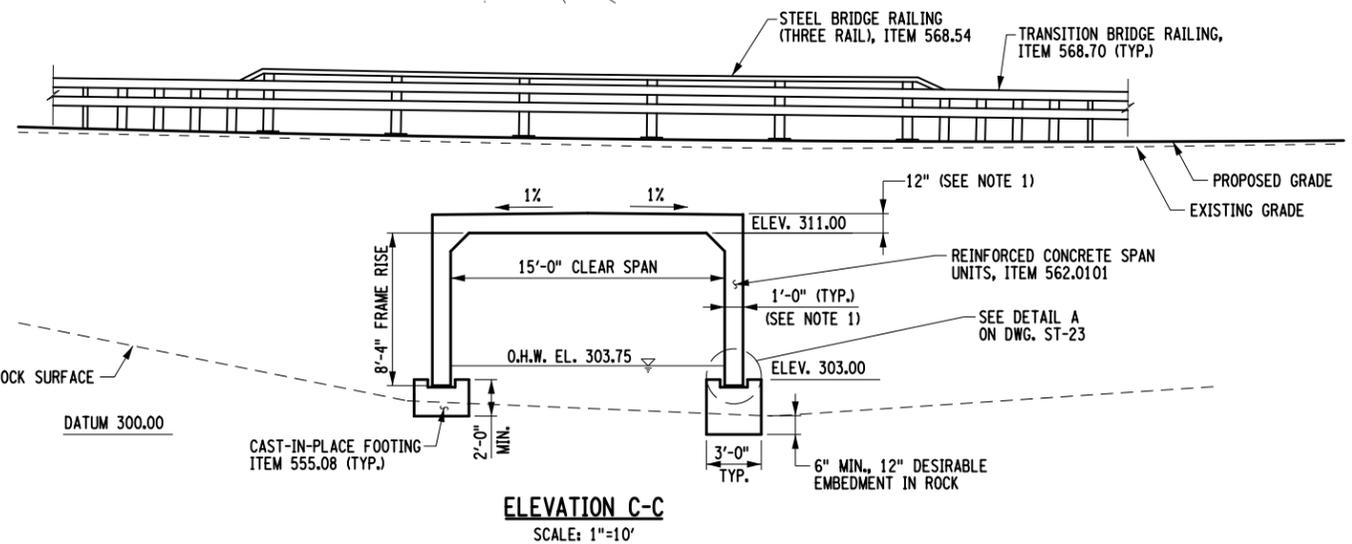


AFFIX SEAL: GREENMAN - PEDERSEN, INC
 ON: APRIL 15, 2021

ALTERED BY:
 ON:

AS-BUILT REVISIONS DESCRIPTION OF ALTERATIONS:	VETERAN'S ROAD CULVERT REPLACEMENT	PIN 1761.09	BRIDGES	CULVERTS	ALL DIMENSIONS IN FT UNLESS OTHERWISE NOTED	CONTRACT NUMBER D036296	
	OVER FIVE MILE CREEK					DRAWING NO. ST-5 SHEET NO. 17	
	TOWN OF TICONDEROGA				PROPOSED BRIDGE PLAN		
	COUNTY: ESSEX	REGION: 1					
IT IS A VIOLATION OF LAW FOR ANY PERSON, UNLESS THEY ARE ACTING UNDER THE DIRECTION OF A LICENSED PROFESSIONAL ENGINEER, ARCHITECT, LANDSCAPE ARCHITECT, OR LAND SURVEYOR, TO ALTER AN ITEM IN ANY WAY. IF AN ITEM BEARING THE STAMP OF A LICENSED PROFESSIONAL IS ALTERED, THE ALTERING ENGINEER, ARCHITECT, LANDSCAPE ARCHITECT, OR LAND SURVEYOR SHALL STAMP THE DOCUMENT AND INCLUDE THE NOTATION "ALTERED BY" FOLLOWED BY THEIR SIGNATURE, THE DATE OF SUCH ALTERATION, AND A SPECIFIC DESCRIPTION OF THE ALTERATION.							

FILE NAME = ... \CADD\176109_CPB_TYP_SEC.P.dgn
 DATE/TIME = 4/15/2021
 USER = skern

DESIGN SUPERVISOR J. SIMKULET
 DESIGN S. KERN
 CHECK B. WEAVER
 DRAFTING F. CIUCCIO
 CHECK S. KERN
 PROJECT MANAGER S. KERN

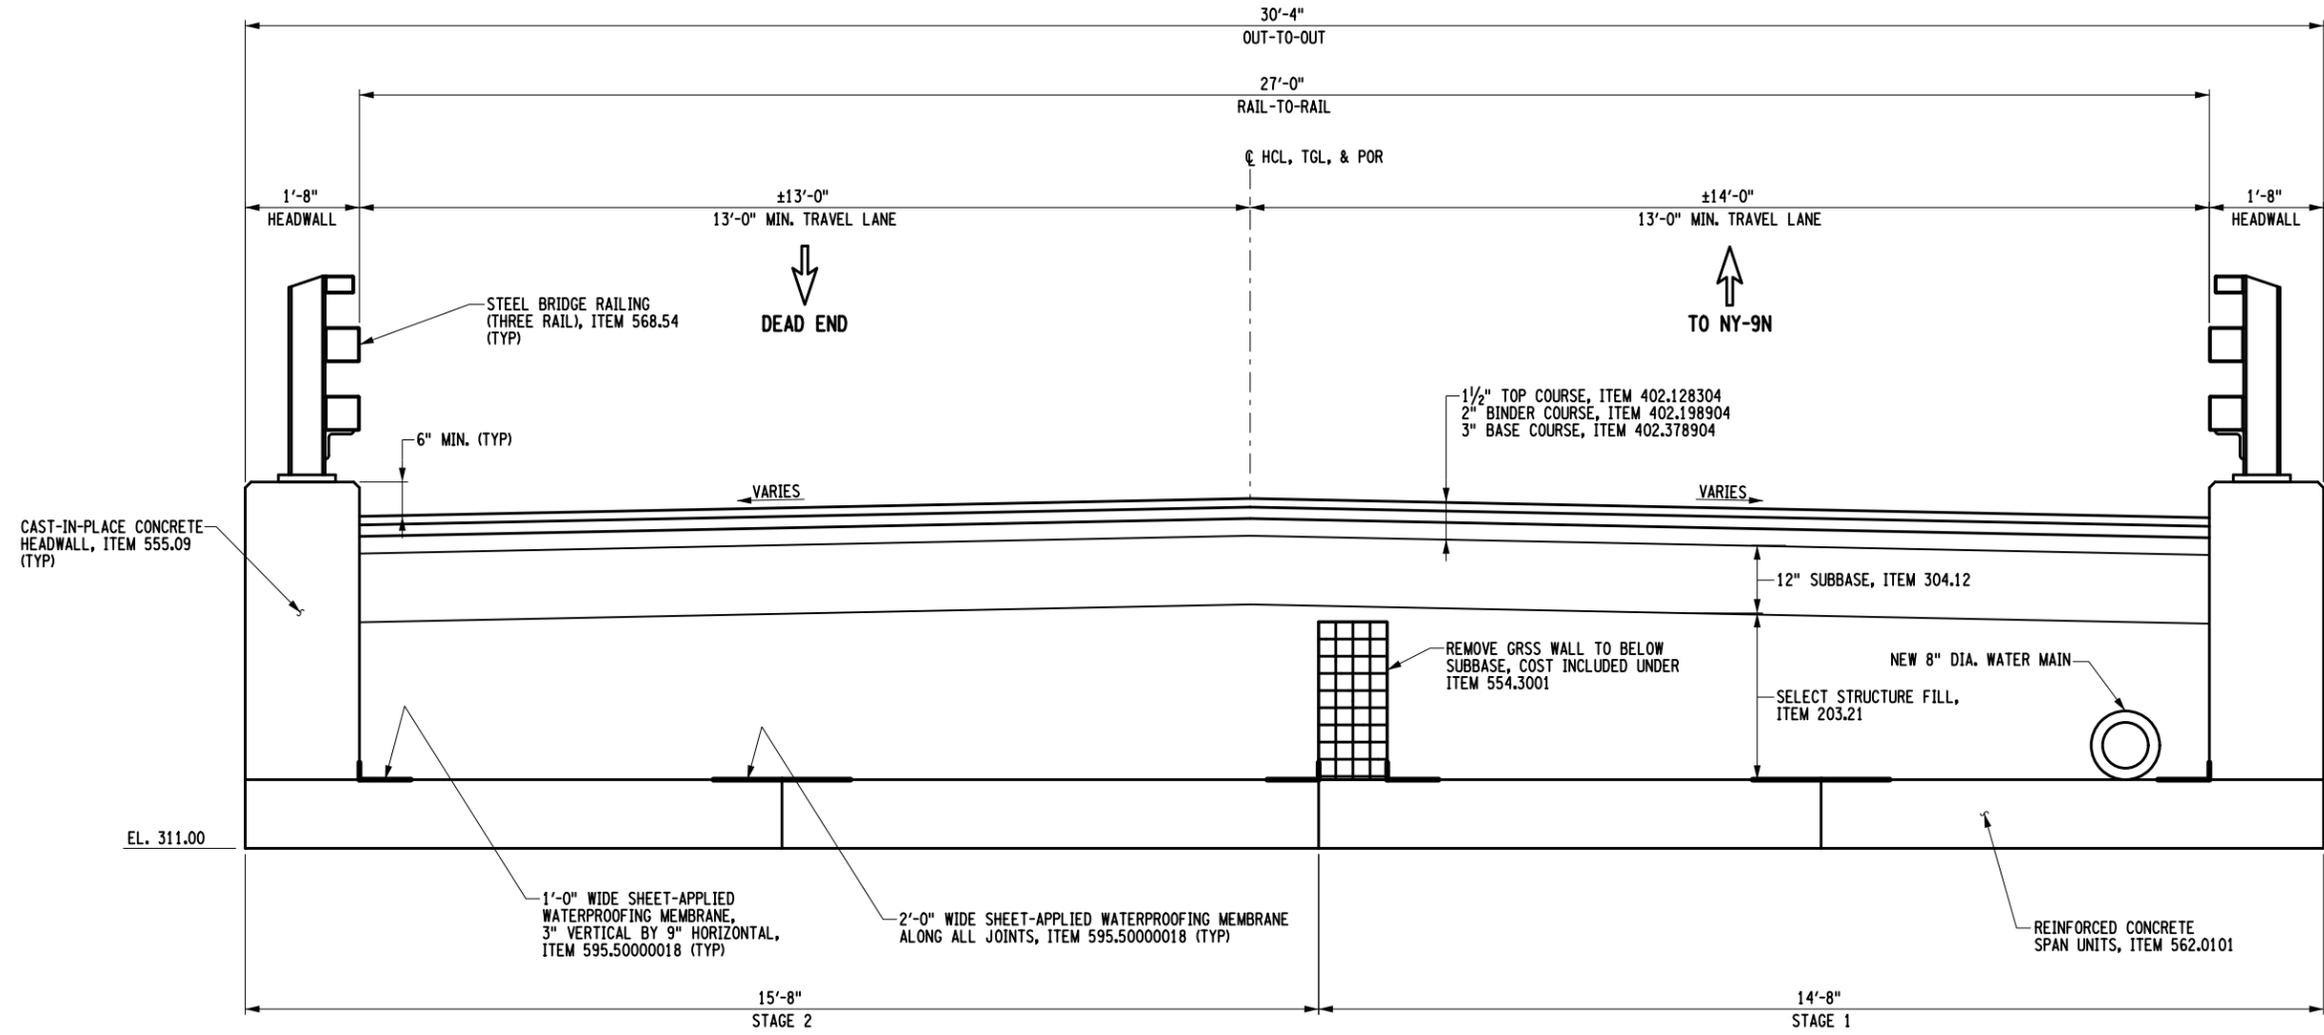

PROPOSED TYPICAL SECTION
 SCALE: 3/8" = 1'-0"


NOTES

- FOUR (4) REINFORCED CONCRETE UNITS ARE ARBITRARILY SHOWN. ACTUAL NUMBER AND WIDTH OF CONCRETE UNITS SHALL BE IN ACCORDANCE WITH CONTRACTOR'S APPROVED DESIGN CALCULATIONS AND SHOP DRAWINGS.


AFFIX SEAL: GREENMAN - PEDERSEN, INC ON: APRIL 15, 2021		ALTERED BY: ON:	
		AS-BUILT REVISIONS	
		DESCRIPTION OF ALTERATIONS:	

VETERAN'S ROAD CULVERT REPLACEMENT	PIN 1761.09	BRIDGES	CULVERTS	ALL DIMENSIONS IN FT UNLESS OTHERWISE NOTED	CONTRACT NUMBER D036296
OVER FIVE MILE CREEK					PROPOSED TYPICAL SECTION
TOWN OF TICONDEROGA					
COUNTY: ESSEX	REGION: 1				
IT IS A VIOLATION OF LAW FOR ANY PERSON, UNLESS THEY ARE ACTING UNDER THE DIRECTION OF A LICENSED PROFESSIONAL ENGINEER, ARCHITECT, LANDSCAPE ARCHITECT, OR LAND SURVEYOR, TO ALTER AN ITEM IN ANY WAY. IF AN ITEM BEARING THE STAMP OF A LICENSED PROFESSIONAL IS ALTERED, THE ALTERING ENGINEER, ARCHITECT, LANDSCAPE ARCHITECT, OR LAND SURVEYOR SHALL STAMP THE DOCUMENT AND INCLUDE THE NOTATION "ALTERED BY" FOLLOWED BY THEIR SIGNATURE, THE DATE OF SUCH ALTERATION, AND A SPECIFIC DESCRIPTION OF THE ALTERATION.					


PROJECT MANAGER S. KERN
 CHECK S. KERN
 DRAFTING F. CIUCCIO
 CHECK B. WEAVER
 DESIGN S. KERN
 JOB MANAGER D. THOMAS
 DESIGN SUPERVISOR J. SIMKULET

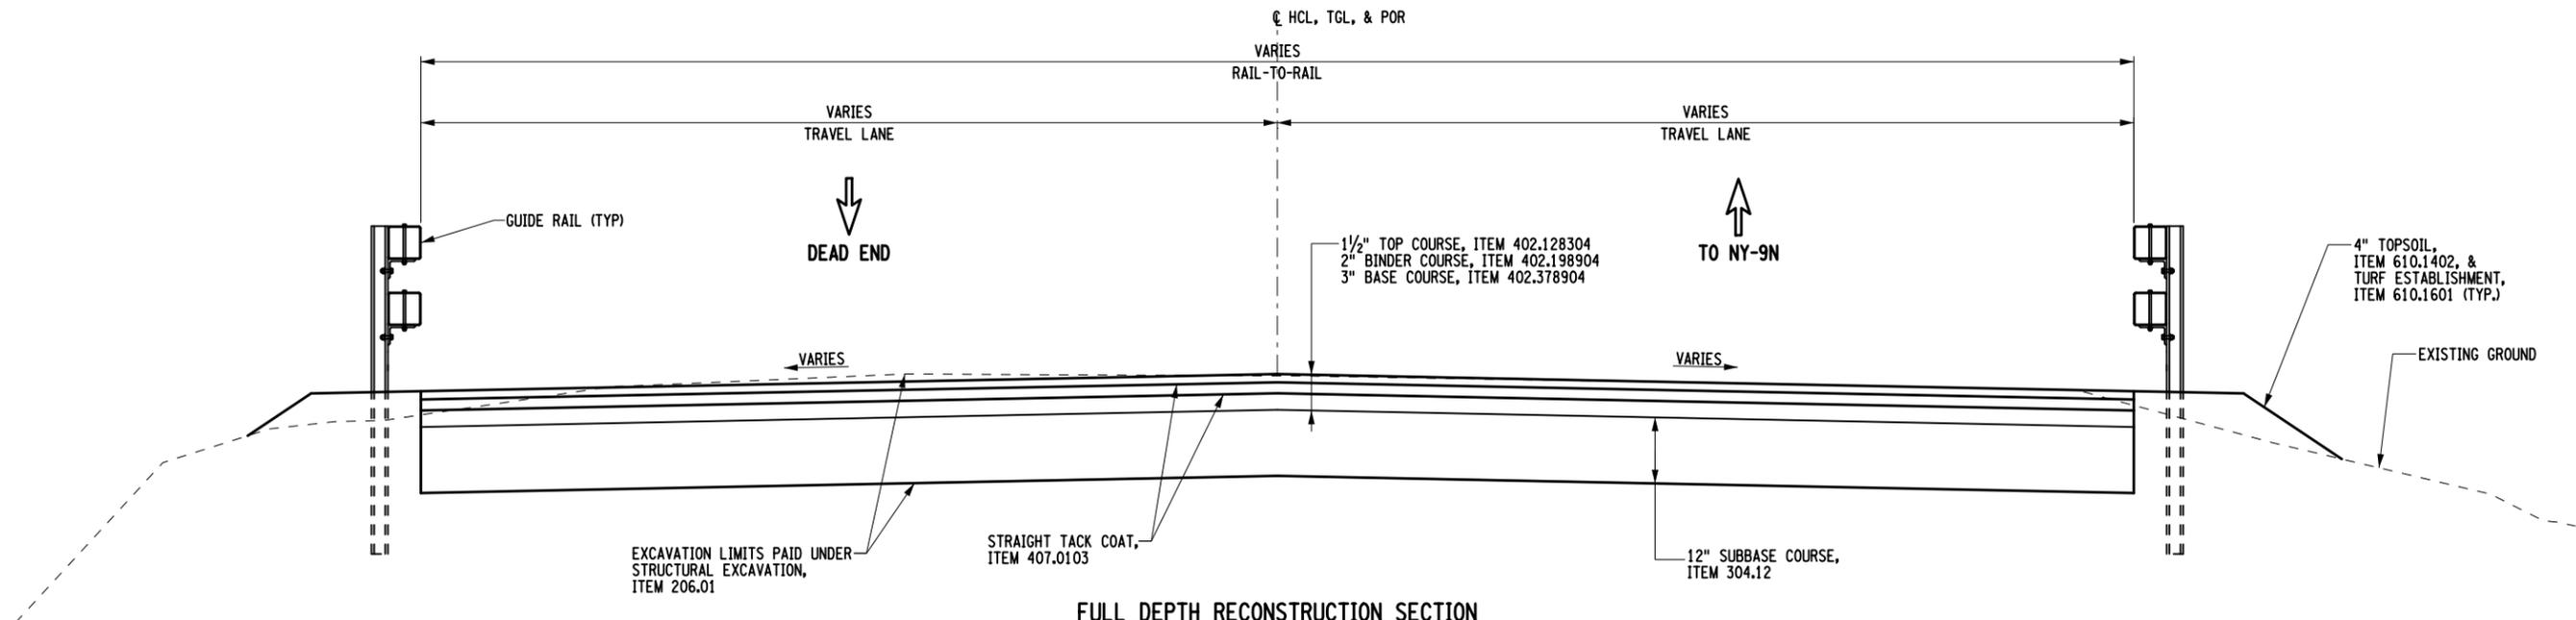

FULL DEPTH RECONSTRUCTION SECTION
 STA. 3+65.00 TO CULVERT
 CULVERT TO STA. 4+50.00
 (STA. 3+90.00 SHOWN)
 SCALE: 3/8"=1'-0"

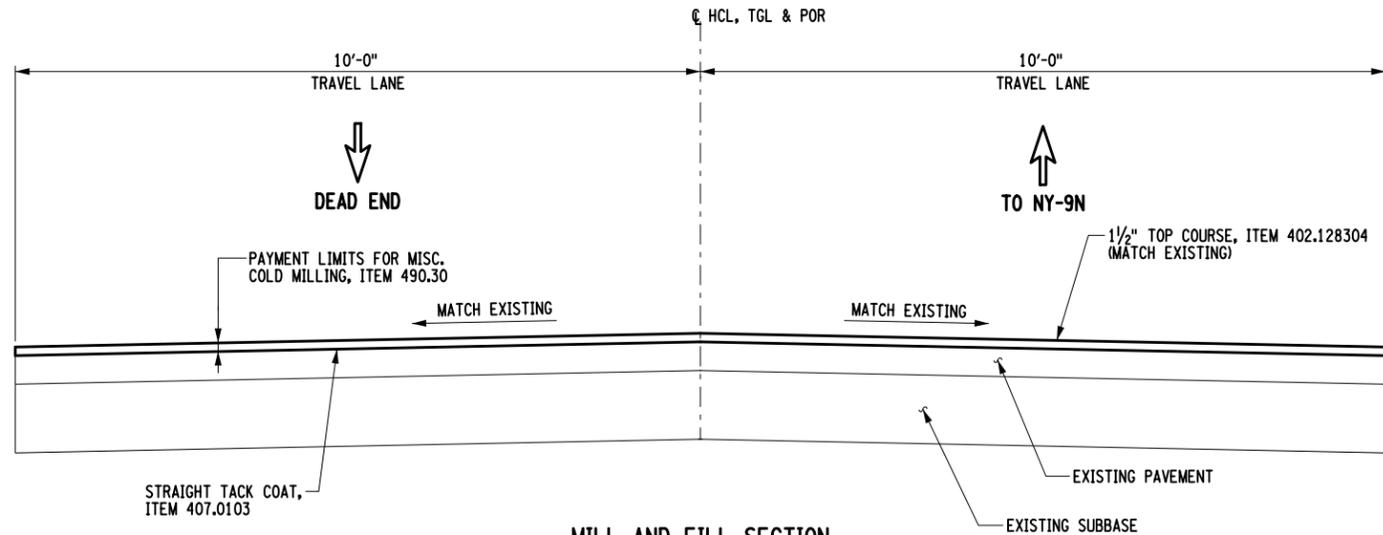

MILL AND FILL SECTION
 STA. 2+50.00 TO STA. 3+65.00
 STA. 4+50.00 TO STA. 5+00.00
 SCALE: 3/8"=1'-0"

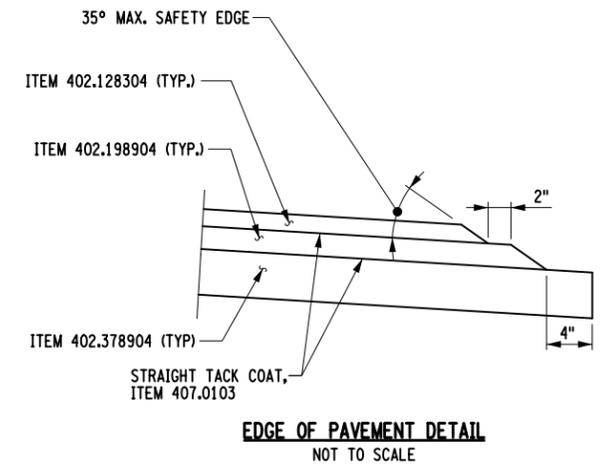

EDGE OF PAVEMENT DETAIL
 NOT TO SCALE

AFFIX SEAL: GREENMAN - PEDERSEN, INC
 ON: APRIL 15, 2021
 ALTERED BY:
 ON:




AS-BUILT REVISIONS DESCRIPTION OF ALTERATIONS:	VETERAN'S ROAD CULVERT REPLACEMENT	PIN 1761.09	BRIDGES	CULVERTS	ALL DIMENSIONS IN FT UNLESS OTHERWISE NOTED	CONTRACT NUMBER D036296
	OVER FIVE MILE CREEK					DRAWING NO. ST-7 SHEET NO. 19
	TOWN OF TICONDEROGA				TYPICAL ROADWAY SECTIONS	
	COUNTY: ESSEX	REGION: 1				


IT IS A VIOLATION OF LAW FOR ANY PERSON, UNLESS THEY ARE ACTING UNDER THE DIRECTION OF A LICENSED PROFESSIONAL ENGINEER, ARCHITECT, LANDSCAPE ARCHITECT, OR LAND SURVEYOR, TO ALTER AN ITEM IN ANY WAY. IF AN ITEM BEARING THE STAMP OF A LICENSED PROFESSIONAL IS ALTERED, THE ALTERING ENGINEER, ARCHITECT, LANDSCAPE ARCHITECT, OR LAND SURVEYOR SHALL STAMP THE DOCUMENT AND INCLUDE THE NOTATION "ALTERED BY" FOLLOWED BY THEIR SIGNATURE, THE DATE OF SUCH ALTERATION, AND A SPECIFIC DESCRIPTION OF THE ALTERATION.

FILE NAME = ...176109_CPB_TYP_SEC_RWY.dgn
 DATE/TIME = 4/15/2021
 USER = skern


PROJECT MANAGER: S. KERN
 CHECK: S. KERN
 DRAFTING: F. CUOCCIO
 CHECK: B. WEAVER
 DESIGN: S. KERN
 JOB MANAGER: D. THOMAS
 DESIGN SUPERVISOR: J. SIMKULET

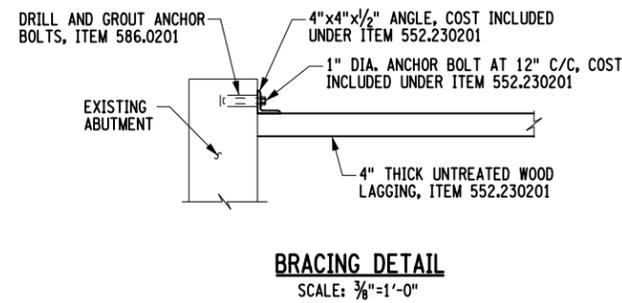

BRACING DETAIL
SCALE: 3/8"=1'-0"

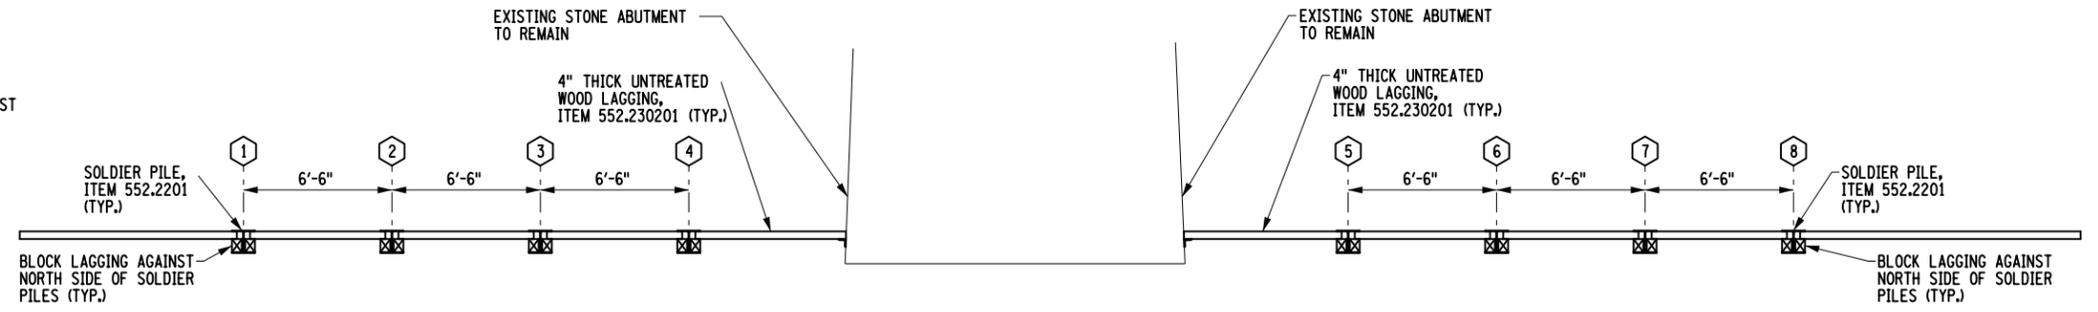


SOLDIER PILE AND LAGGING WALL PLAN
SCALE: 1/8"=1'-0"

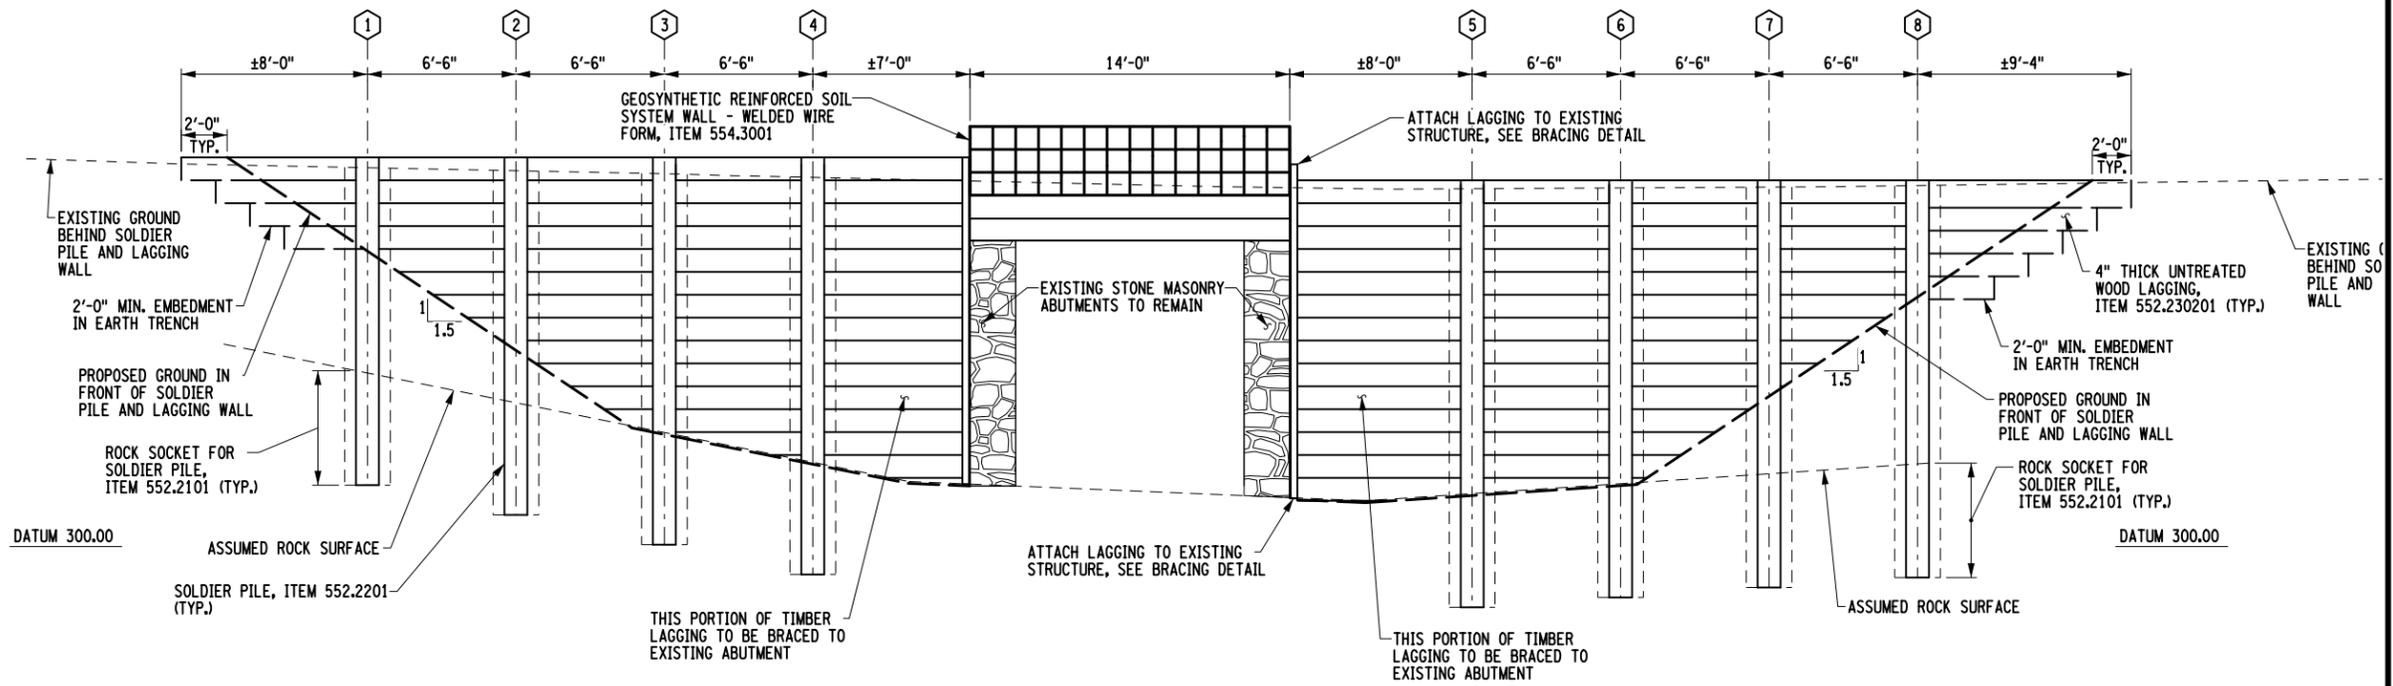

SOLDIER PILE AND LAGGING WALL ELEVATION
SCALE: 1/8"=1'-0"

SOLDIER PILE TABLE														
PILE NUMBER	STATION	OFFSET		COORDINATES		PILE TOP ELEV. (FT)	ESTIMATED DEPTH OF EXCAVATION (FT)	ESTIMATED PILE TIP ELEV. (FT)	ESTIMATED PILE LENGTH (FT)	ASSUMED ROCK ELEV. (FT)	MINIMUM ROCK SOCKET (FT)	SUGGESTED SOLDIER PILE SECTION	MINIMUM DIA. OF HOLE (IN)	AS-BUILT PILE LENGTH (FT)
		(FT)	SIDE	NORTHING	EASTING									
1	3+73.97	1.74	LEFT	1840439.1851	768292.7520	317.00	3.64	302.50	14.50	307.50	5.00	HP 12x53	24	
2	3+80.45	1.53	LEFT	1840440.0185	768299.1983	317.00	7.84	301.00	16.00	306.00	5.00	HP 12x53	24	
3	3+86.94	1.34	LEFT	1840440.8518	768305.6447	317.00	11.31	300.00	17.00	305.00	5.00	HP 12x53	24	
4	3+93.43	1.20	LEFT	1840441.6851	768312.0910	317.00	12.44	298.50	18.50	303.50	5.00	HP 12x53	24	
5	4+22.28	0.95	LEFT	1840445.3864	768340.7238	316.00	13.32	297.00	19.00	302.00	5.00	HP 12x53	24	
6	4+28.78	0.95	LEFT	1840446.2197	768347.1701	316.00	12.92	297.50	18.50	302.50	5.00	HP 12x53	24	
7	4+35.28	0.95	LEFT	1840447.0530	768353.6165	316.00	9.14	298.00	18.00	303.00	5.00	HP 12x53	24	
8	4+41.77	0.98	LEFT	1840447.8863	768360.0629	316.00	4.87	298.50	17.50	303.50	5.00	HP 12x53	24	

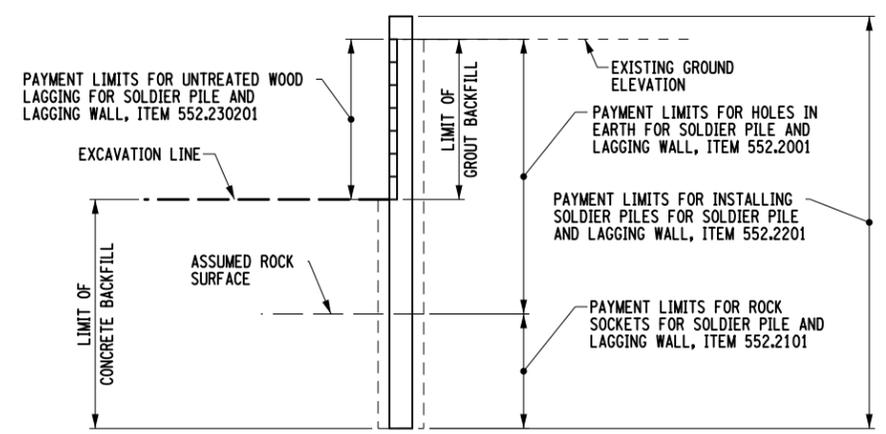

TYPICAL SECTION FOR PILES PLACED IN A HOLE
SCALE: 1/8"=1'-0"

AFFIX SEAL: GREENMAN - PEDERSEN, INC
ON: APRIL 15, 2021

ALTERED BY:
ON:



NOTES


- WHEN NO LONGER NEEDED FOR EXCAVATION SUPPORT, SOLDIER PILES AND LAGGING WALLS LOCATED INSIDE THE ROAD-BED LIMITS ARE TO BE CUT OFF AND REMOVED TO THE SUBGRADE SURFACE.
- DO NOT USE WEATHERING STEEL (ASTM A588) FOR SOLDIER PILES.

AS-BUILT REVISIONS DESCRIPTION OF ALTERATIONS:	VETERAN'S ROAD CULVERT REPLACEMENT	PIN 1761.09	BRIDGES	CULVERTS	ALL DIMENSIONS IN FT UNLESS OTHERWISE NOTED	CONTRACT NUMBER D036296
	OVER FIVE MILE CREEK					DRAWING NO. ST-9
	TOWN OF TICONDEROGA					SHEET NO. 21
COUNTY: ESSEX	REGION: 1			SOLDIER PILE & LAGGING WALL DETAILS		
IT IS A VIOLATION OF LAW FOR ANY PERSON, UNLESS THEY ARE ACTING UNDER THE DIRECTION OF A LICENSED PROFESSIONAL ENGINEER, ARCHITECT, LANDSCAPE ARCHITECT, OR LAND SURVEYOR, TO ALTER AN ITEM IN ANY WAY. IF AN ITEM BEARING THE STAMP OF A LICENSED PROFESSIONAL IS ALTERED, THE ALTERING ENGINEER, ARCHITECT, LANDSCAPE ARCHITECT, OR LAND SURVEYOR SHALL STAMP THE DOCUMENT AND INCLUDE THE NOTATION "ALTERED BY" FOLLOWED BY THEIR SIGNATURE, THE DATE OF SUCH ALTERATION, AND A SPECIFIC DESCRIPTION OF THE ALTERATION.				TOWN OF TICONDEROGA		

FILE NAME = ...CADD\176109_CPB_SPL_PLN.dgn
 DATE/TIME = 4/15/2021
 USER = skern

FILE NAME = \\CADD\176109_CPB_EXC_PLN-1.dgn
 DATE/TIME = 4/15/2021
 USER = skern

DESIGN SUPERVISOR J. SIMKULET
 JOB MANAGER D. THOMAS
 DESIGN S. KERN
 CHECK B. WEAVER
 DRAFTING F. CUOCCIO
 CHECK S. KERN
 PROJECT MANAGER S. KERN

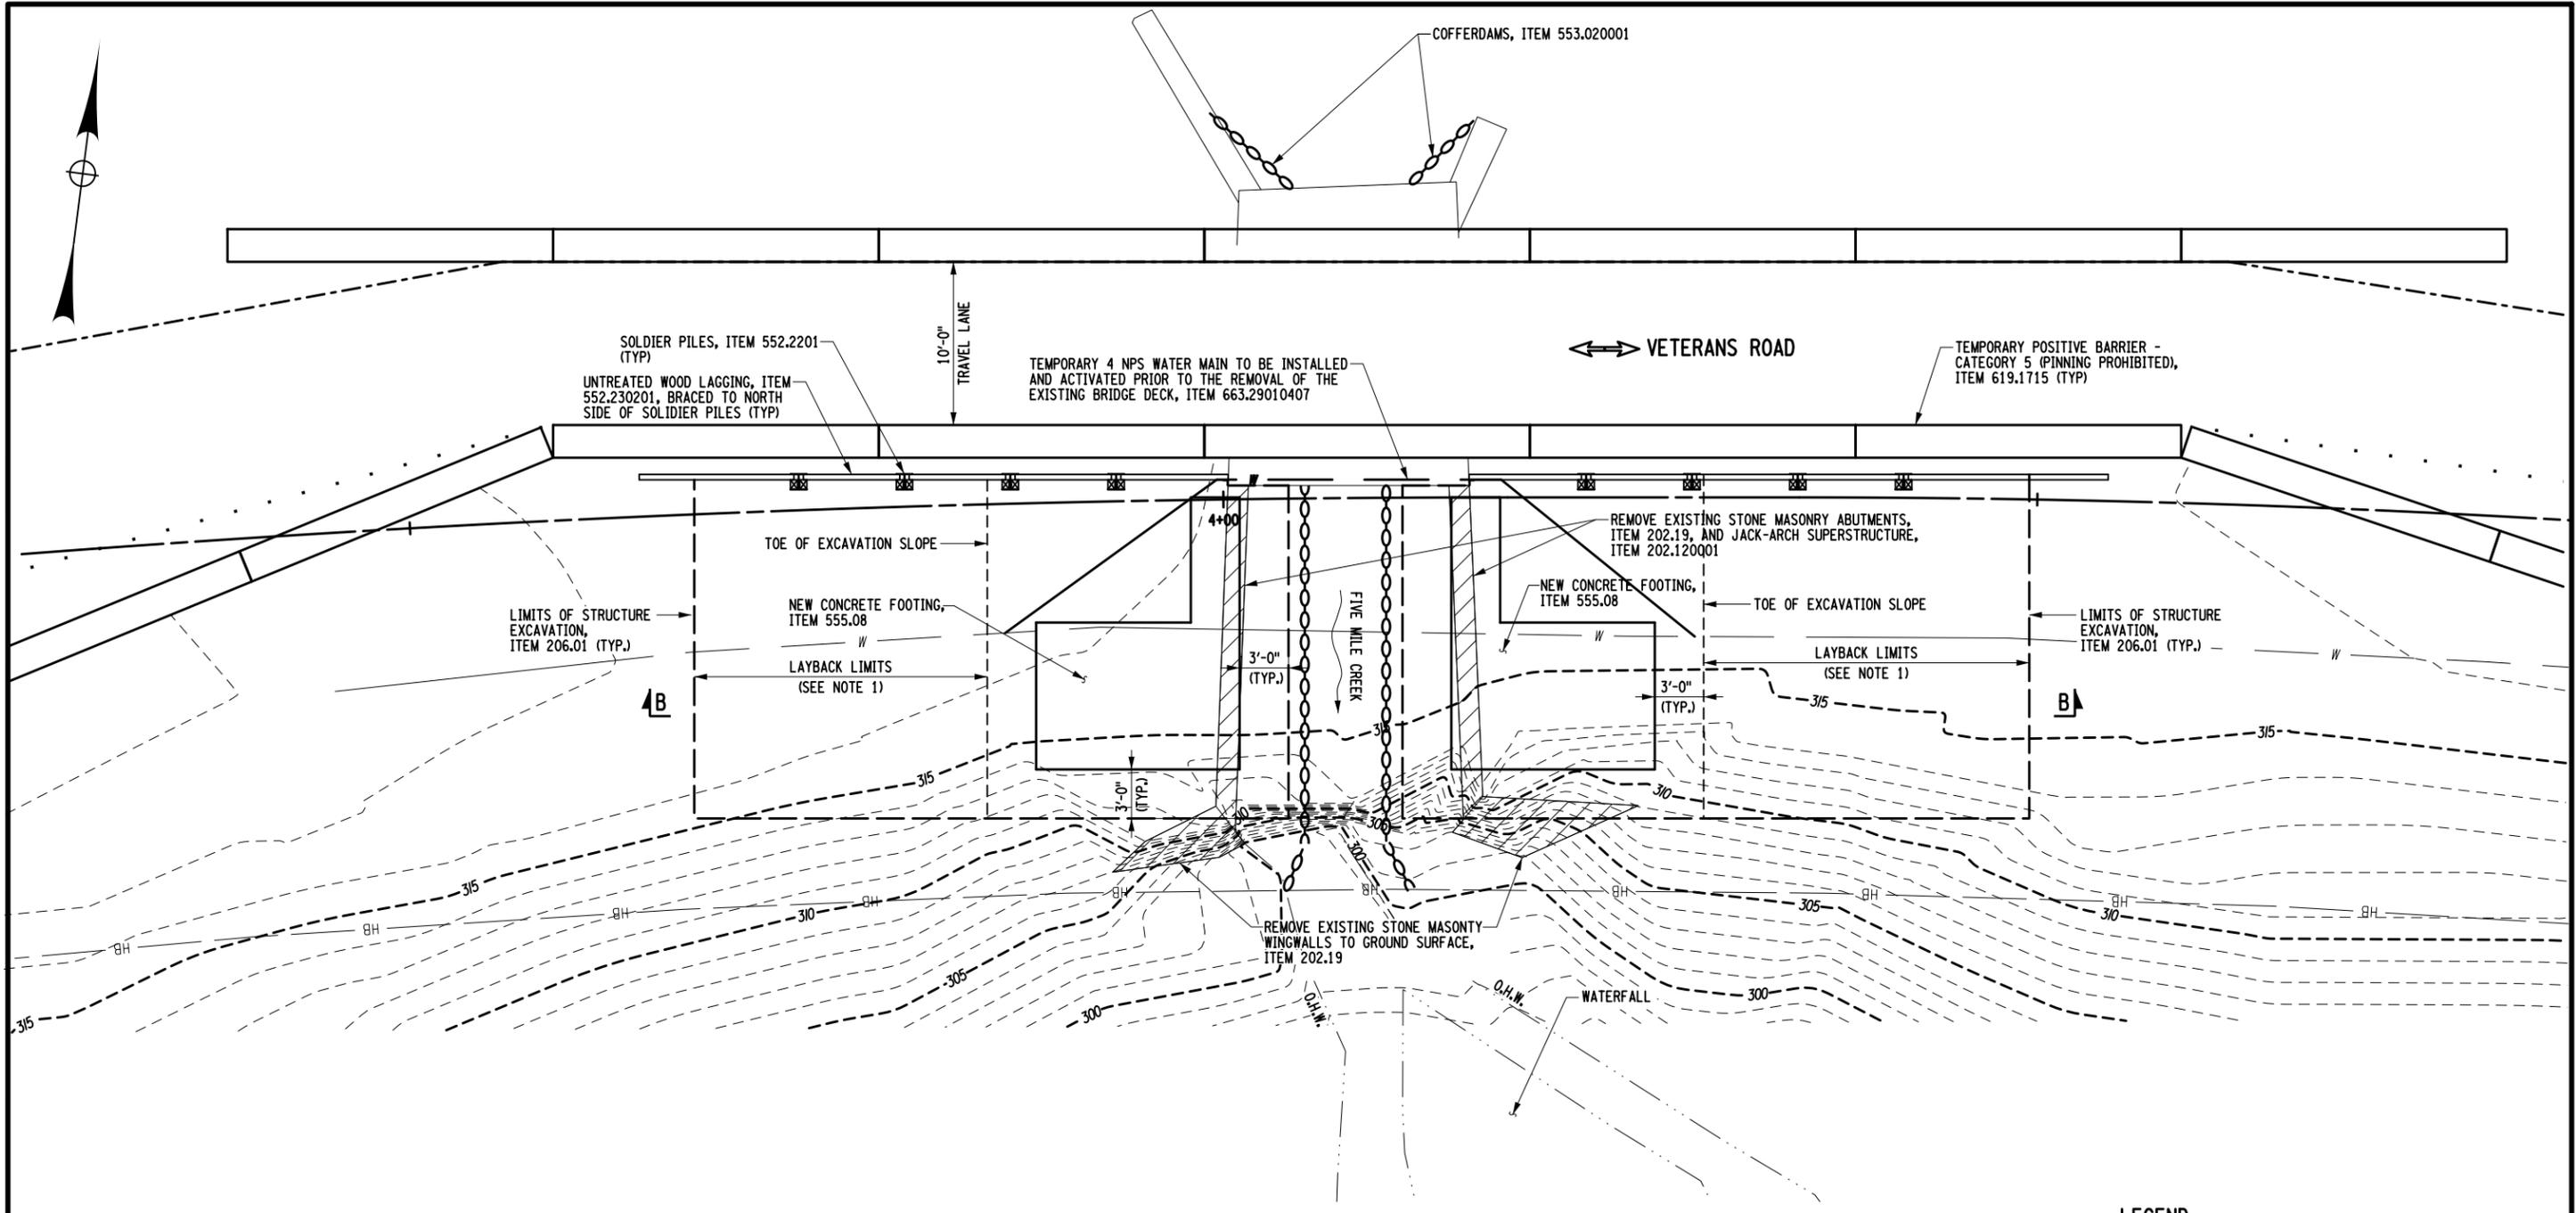

NOTES:
 1. FOR STRUCTURE EXCAVATION OVER 5'-0" DEEP USE A LAYBACK OF 1 VERTICAL ON 1.5 HORIZONTAL FROM THE BOTTOM OF EXCAVATION.

LEGEND

- LIMITS / PAYMENT LINES FOR STRUCTURE EXCAVATION, ITEM 206.01
- ▨ REMOVAL OF SUBSTRUCTURES, ITEM 202.19
- COFFERDAMS (TYPE 2), ITEM 553.020001

5 0 5 10 15 20'

AFFIX SEAL: GREENMAN - PEDERSEN, INC
 ON: APRIL 15, 2021
 ALTERED BY:
 ON:



REFERENCE
 FOR SECTION B-B, SEE DWG. ST-14


AS-BUILT REVISIONS DESCRIPTION OF ALTERATIONS:	VETERAN'S ROAD CULVERT REPLACEMENT	PIN 1761.09	BRIDGES	CULVERTS	ALL DIMENSIONS IN FT UNLESS OTHERWISE NOTED	CONTRACT NUMBER D036296
	OVER FIVE MILE CREEK					
	TOWN OF TICONDEROGA				STAGE 1 EXCAVATION PLAN	DRAWING NO. ST-10 SHEET NO. 22
	COUNTY: ESSEX REGION: 1					

IT IS A VIOLATION OF LAW FOR ANY PERSON, UNLESS THEY ARE ACTING UNDER THE DIRECTION OF A LICENSED PROFESSIONAL ENGINEER, ARCHITECT, LANDSCAPE ARCHITECT, OR LAND SURVEYOR, TO ALTER AN ITEM IN ANY WAY. IF AN ITEM BEARING THE STAMP OF A LICENSED PROFESSIONAL IS ALTERED, THE ALTERING ENGINEER, ARCHITECT, LANDSCAPE ARCHITECT, OR LAND SURVEYOR SHALL STAMP THE DOCUMENT AND INCLUDE THE NOTATION "ALTERED BY" FOLLOWED BY THEIR SIGNATURE, THE DATE OF SUCH ALTERATION, AND A SPECIFIC DESCRIPTION OF THE ALTERATION.

GPI GREENMAN-PEDERSEN, INC. CONSULTING ENGINEERS
 TOWN OF TICONDEROGA

FILE NAME = \\CADD\176109_CPB_ERW_PLN-1.dgn
 DATE/TIME = 4/15/2021
 USER = skern

PROJECT MANAGER S. KERN
 CHECK S. KERN
 DRAFTING F. CIUCCIO
 CHECK B. WEAVER
 DESIGN S. KERN
 JOB MANAGER D. THOMAS
 DESIGN SUPERVISOR J. SIMKULET

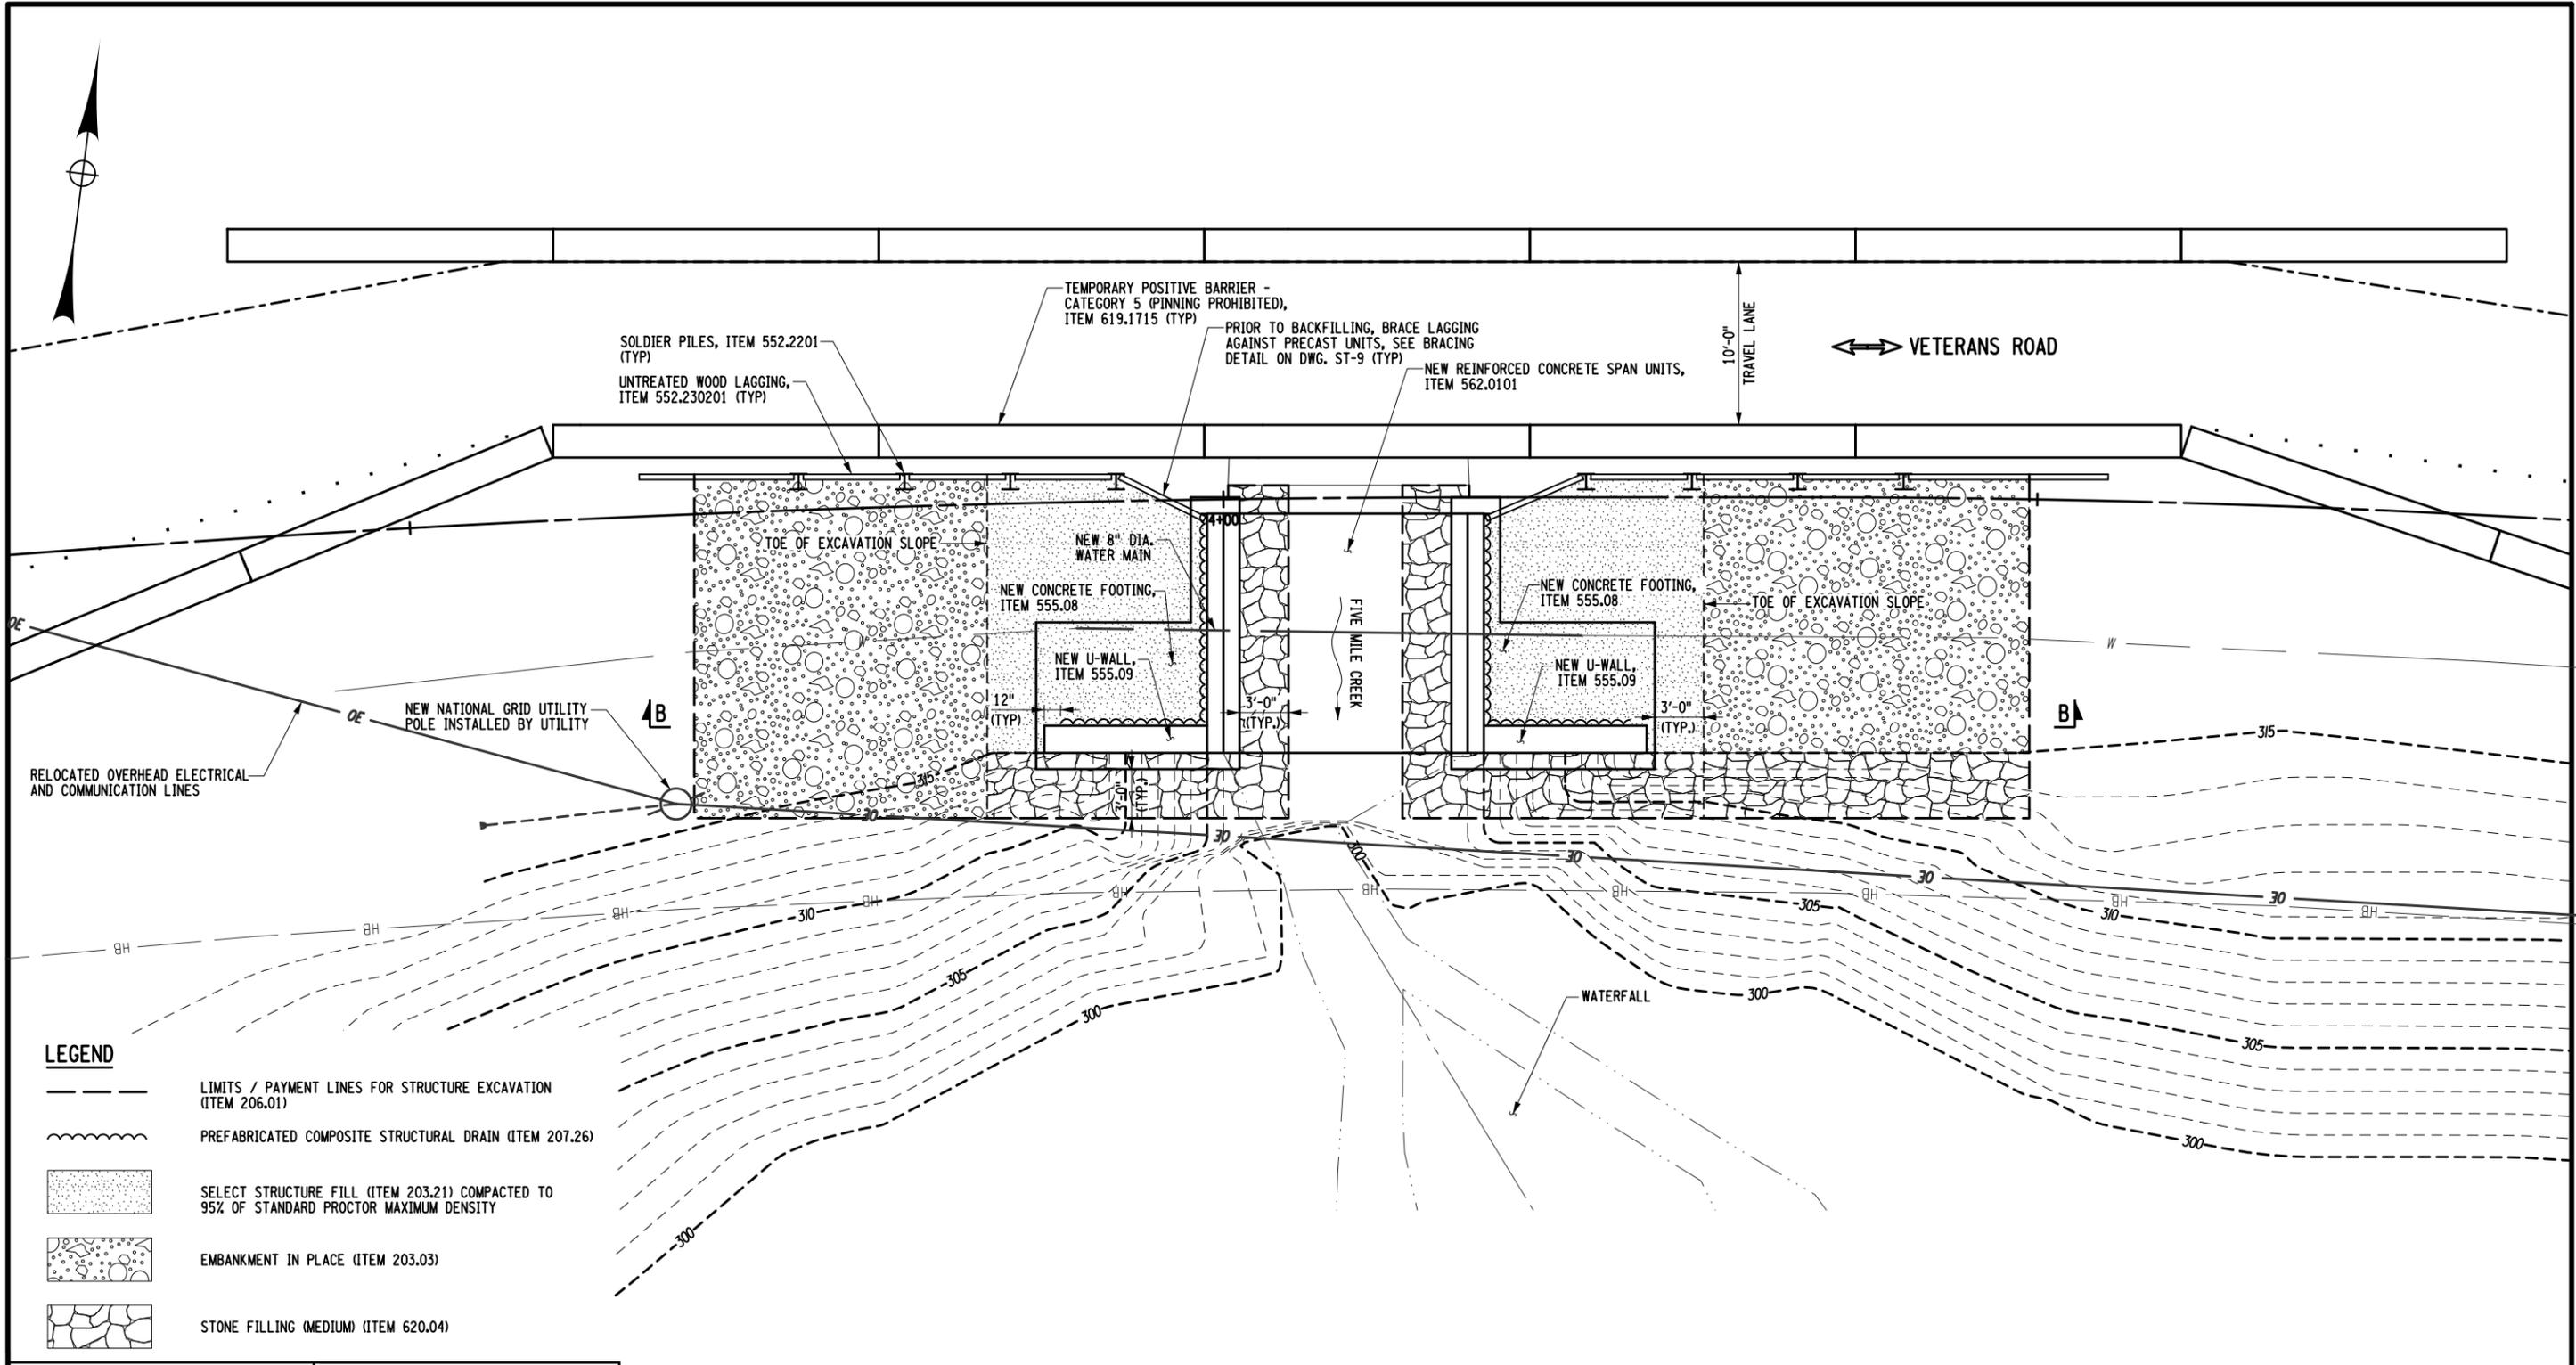

AFFIX SEAL: GREENMAN - PEDERSEN, INC
 ON: APRIL 15, 2021

ALTERED BY:
 ON:

REFERENCE
 FOR SECTION B-B, SEE DWG. ST-14

AS-BUILT REVISIONS DESCRIPTION OF ALTERATIONS:	VETERAN'S ROAD CULVERT REPLACEMENT	PIN 1761.09	BRIDGES	CULVERTS	ALL DIMENSIONS IN FT UNLESS OTHERWISE NOTED	CONTRACT NUMBER D036296
	OVER FIVE MILE CREEK					STAGE 1 BACKFILL PLAN
	TOWN OF TICONDEROGA	COUNTY: ESSEX	REGION: 1			

IT IS A VIOLATION OF LAW FOR ANY PERSON, UNLESS THEY ARE ACTING UNDER THE DIRECTION OF A LICENSED PROFESSIONAL ENGINEER, ARCHITECT, LANDSCAPE ARCHITECT, OR LAND SURVEYOR, TO ALTER AN ITEM IN ANY WAY. IF AN ITEM BEARING THE STAMP OF A LICENSED PROFESSIONAL IS ALTERED, THE ALTERING ENGINEER, ARCHITECT, LANDSCAPE ARCHITECT, OR LAND SURVEYOR SHALL STAMP THE DOCUMENT AND INCLUDE THE NOTATION "ALTERED BY" FOLLOWED BY THEIR SIGNATURE, THE DATE OF SUCH ALTERATION, AND A SPECIFIC DESCRIPTION OF THE ALTERATION.


GPI GREENMAN-PEDERSEN, INC. CONSULTING ENGINEERS

TOWN OF TICONDEROGA



FILE NAME = ...\\CADD\176109_CPB_ERW_PLN-2.dgn
 DATE/TIME = 4/15/2021
 USER = skern

DESIGN SUPERVISOR J. SIMKULET
 JOB MANAGER D. THOMAS
 DESIGN S. KERN
 CHECK B. WEAVER
 DRAFTING F. CIUCCIO
 CHECK S. KERN
 PROJECT MANAGER S. KERN

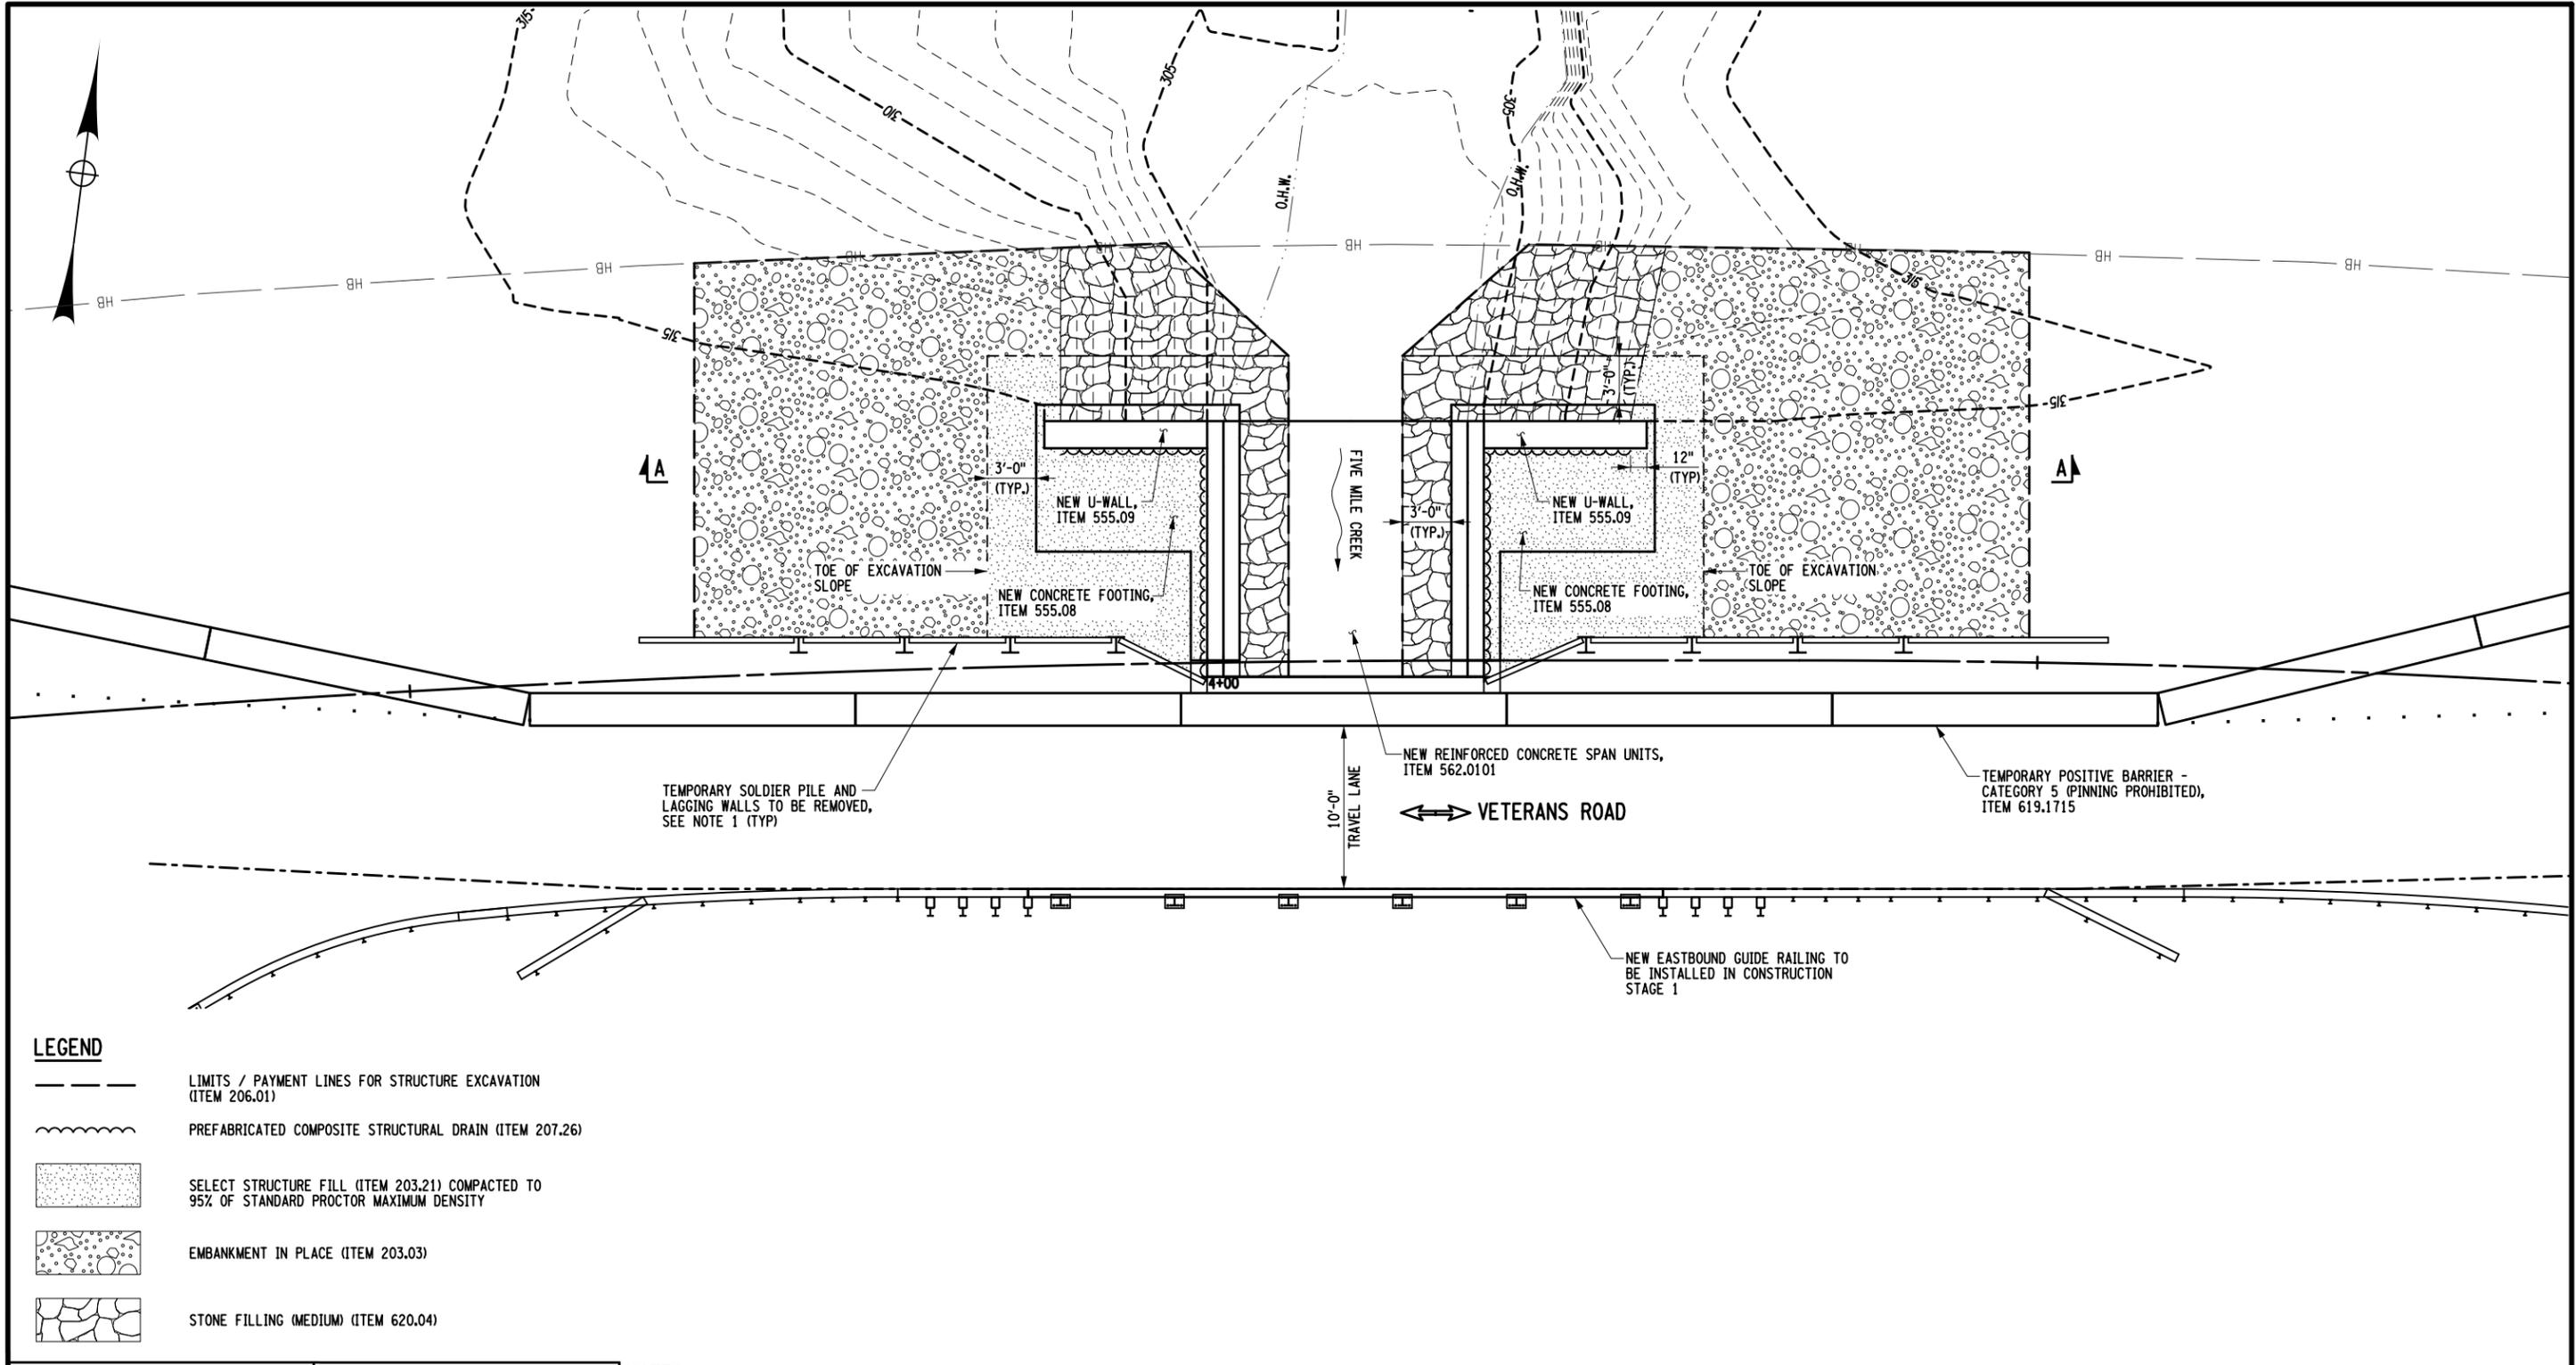

LEGEND

	LIMITS / PAYMENT LINES FOR STRUCTURE EXCAVATION (ITEM 206.01)
	PREFABRICATED COMPOSITE STRUCTURAL DRAIN (ITEM 207.26)
	SELECT STRUCTURE FILL (ITEM 203.21) COMPACTED TO 95% OF STANDARD PROCTOR MAXIMUM DENSITY
	EMBANKMENT IN PLACE (ITEM 203.03)
	STONE FILLING (MEDIUM) (ITEM 620.04)

NOTES:
 1. SOLDIER PILE AND LAGGING WALLS LOCATED INSIDE THE ROAD-BED LIMITS ARE TO BE CUT OFF AND REMOVED TO THE SUBGRADE SURFACE.

REFERENCE
 FOR SECTION A-A, SEE DWG. ST-14




AS-BUILT REVISIONS DESCRIPTION OF ALTERATIONS:	VETERAN'S ROAD CULVERT REPLACEMENT	PIN 1761.09	BRIDGES	CULVERTS	ALL DIMENSIONS IN FT UNLESS OTHERWISE NOTED	CONTRACT NUMBER D036296
	OVER FIVE MILE CREEK					STAGE 2 BACKFILL PLAN
	TOWN OF TICONDEROGA	REGION: 1				

IT IS A VIOLATION OF LAW FOR ANY PERSON, UNLESS THEY ARE ACTING UNDER THE DIRECTION OF A LICENSED PROFESSIONAL ENGINEER, ARCHITECT, LANDSCAPE ARCHITECT, OR LAND SURVEYOR, TO ALTER AN ITEM IN ANY WAY. IF AN ITEM BEARING THE STAMP OF A LICENSED PROFESSIONAL IS ALTERED, THE ALTERING ENGINEER, ARCHITECT, LANDSCAPE ARCHITECT, OR LAND SURVEYOR SHALL STAMP THE DOCUMENT AND INCLUDE THE NOTATION "ALTERED BY" FOLLOWED BY THEIR SIGNATURE, THE DATE OF SUCH ALTERATION, AND A SPECIFIC DESCRIPTION OF THE ALTERATION.




PROJECT MANAGER S. KERN
 CHECK S. KERN
 DRAFTING F. CIUCCIO
 CHECK B. WEAVER
 DESIGN S. KERN
 JOB MANAGER D. THOMAS
 DESIGN SUPERVISOR J. SIMKULET

FILE NAME = ... \CADD\176109_CPB_ERW_SEC.dgn
 DATE/TIME = 4/15/2021
 USER = skern

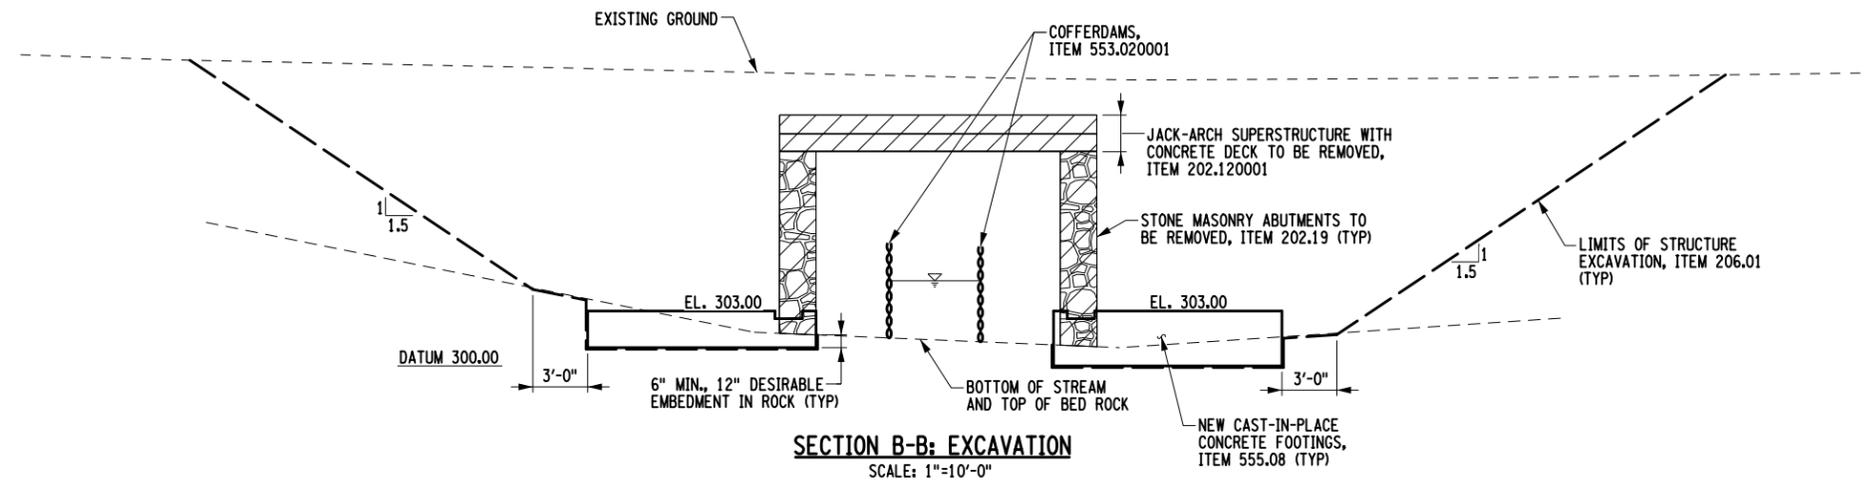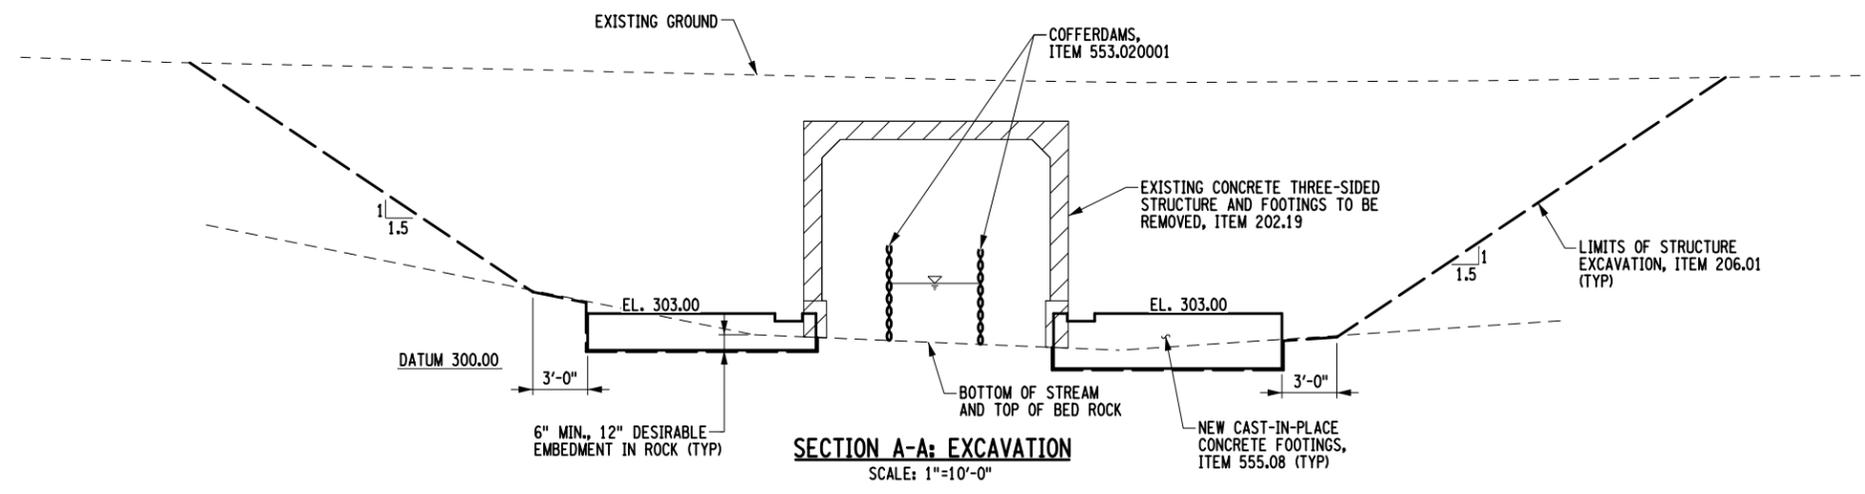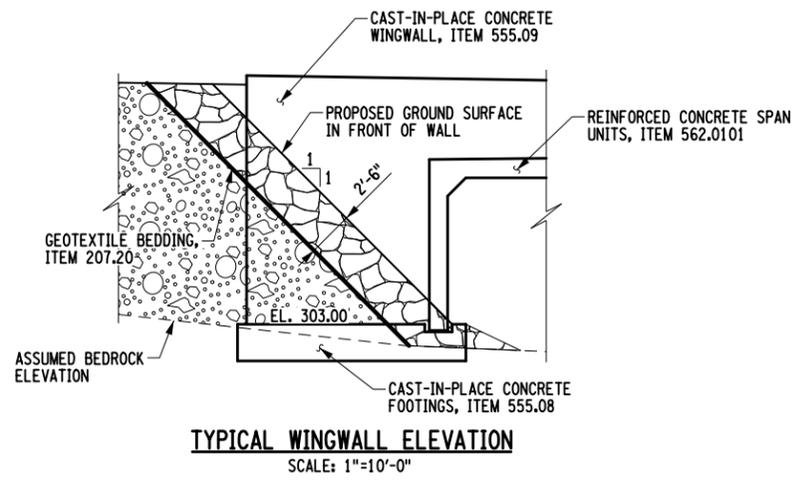

- LEGEND**
- LIMITS / PAYMENT LINES FOR STRUCTURE EXCAVATION (ITEM 206.01)
 - ~~~ PREFABRICATED COMPOSITE STRUCTURAL DRAIN (ITEM 207.26)
 - ⊗ COFFERDAMS (TYPE 2), ITEM 553.020001
 - ▨ REMOVAL OF SUBSTRUCTURES, ITEM 202.19
 - ▤ SELECT STRUCTURE FILL (ITEM 203.21) COMPACTED TO 95% OF STANDARD PROCTOR MAXIMUM DENSITY
 - ▥ EMBANKMENT IN PLACE (ITEM 203.03)
 - ▧ STONE FILLING (MEDIUM) (ITEM 620.04)

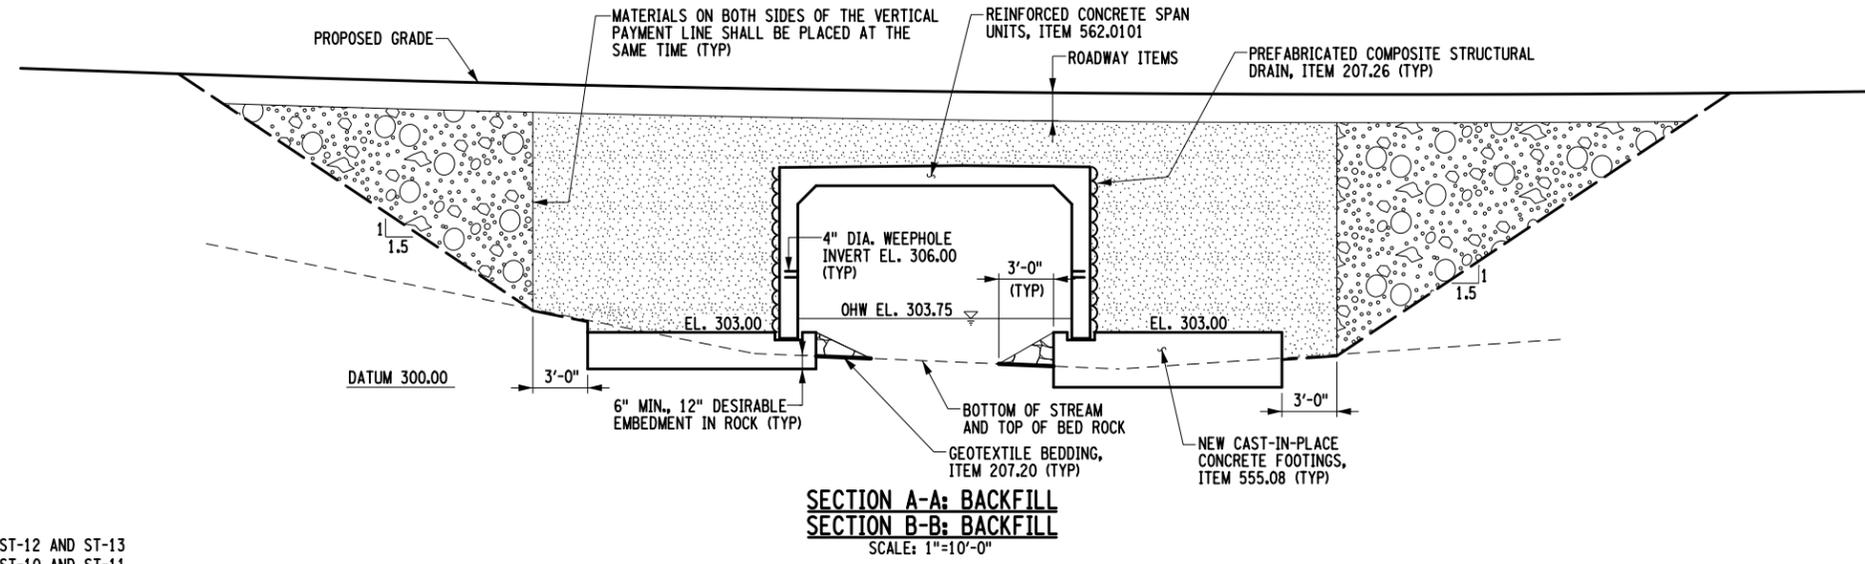

AFFIX SEAL: GREENMAN - PEDERSEN, INC
 ON: APRIL 15, 2021
 ALTERED BY:
 ON:



REFERENCE
 FOR SECTION A-A, SEE DWG. ST-12 AND ST-13
 FOR SECTION B-B, SEE DWG. ST-10 AND ST-11


AS-BUILT REVISIONS DESCRIPTION OF ALTERATIONS:	VETERAN'S ROAD CULVERT REPLACEMENT	PIN 1761.09	BRIDGES	CULVERTS	ALL DIMENSIONS IN FT UNLESS OTHERWISE NOTED	CONTRACT NUMBER D036296
	OVER FIVE MILE CREEK					EARTHWORK SECTIONS
	TOWN OF TICONDEROGA	REGION: 1				

IT IS A VIOLATION OF LAW FOR ANY PERSON, UNLESS THEY ARE ACTING UNDER THE DIRECTION OF A LICENSED PROFESSIONAL ENGINEER, ARCHITECT, LANDSCAPE ARCHITECT, OR LAND SURVEYOR, TO ALTER AN ITEM IN ANY WAY. IF AN ITEM BEARING THE STAMP OF A LICENSED PROFESSIONAL IS ALTERED, THE ALTERING ENGINEER, ARCHITECT, LANDSCAPE ARCHITECT, OR LAND SURVEYOR SHALL STAMP THE DOCUMENT AND INCLUDE THE NOTATION "ALTERED BY" FOLLOWED BY THEIR SIGNATURE, THE DATE OF SUCH ALTERATION, AND A SPECIFIC DESCRIPTION OF THE ALTERATION.



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 USER = skern


DESIGN SUPERVISOR J. SIMKULET
 JOB MANAGER D. THOMAS
 DESIGN S. KERN
 CHECK B. WEAVER
 DRAFTING F. CIUCCIO
 CHECK S. KERN
 PROJECT MANAGER S. KERN

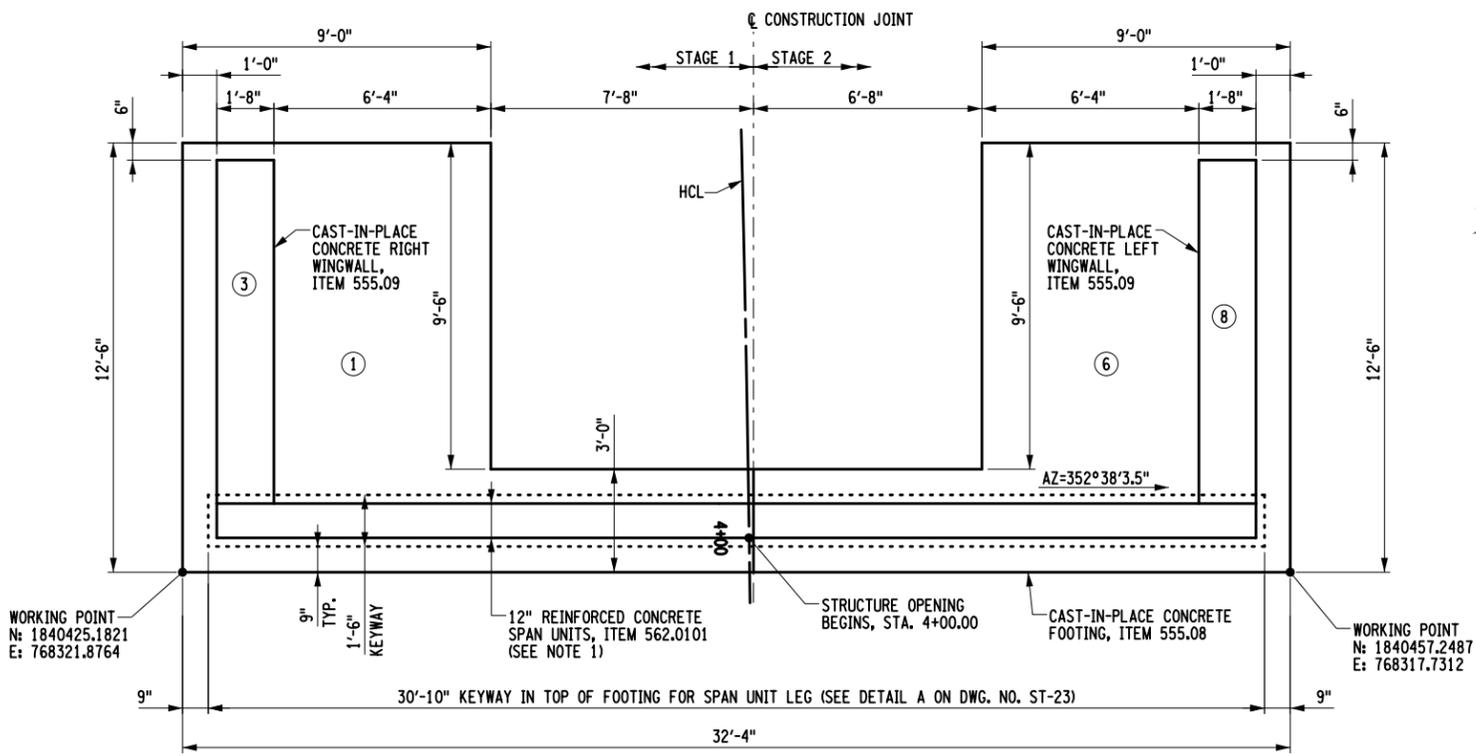

BEGIN ABUTMENT PLAN
 SCALE: 3/16"=1'-0"

NOTES:

- THE NUMBER AND SIZE OF REINFORCED CONCRETE SPAN UNITS ARE ARBITRARILY SHOWN. ACTUAL NUMBER AND DIMENSIONS OF CONCRETE UNITS SHALL BE IN ACCORDANCE WITH CONTRACTOR'S APPROVED DESIGN CALCULATIONS AND SHOP DRAWINGS.
- ADHERE TO THE FOLLOWING PROCEDURES:
 - IF THE ROCK SURFACE IS WITHIN 2 FEET OF EL. 301.00, ADHERE TO THE FOLLOWING:
 - IF THE ROCK SURFACE IS HIGHER, REMOVE THE ROCK SO THAT THE MINIMUM FOOTING THICKNESS OF 2 FEET CAN BE MAINTAINED.
 - IF THE ROCK SURFACE IS LOWER, PLACE ADDITIONAL CONCRETE SO THAT THE TOP OF FOOTING EL. 303.00 CAN BE MAINTAINED.
 - IF THE ROCK SURFACE IS MORE THAN 2 FEET FROM EL. 301.00, THE RESIDENT ENGINEER WILL NOTIFY THE ENGINEER OF THIS CONDITION. THE ENGINEER WILL DETERMINE IF: THE FOUNDATION FOR THE SUBSTRUCTURE HAS TO BE REDESIGNED, ADDITIONAL FOOTING CONCRETE HAS TO BE PLACED, OR ADDITIONAL ROCK HAS TO BE EXCAVATED.
- A FOOTING THICKNESS OF 3'-0" IS ASSUMED FOR ESTIMATING PURPOSES.

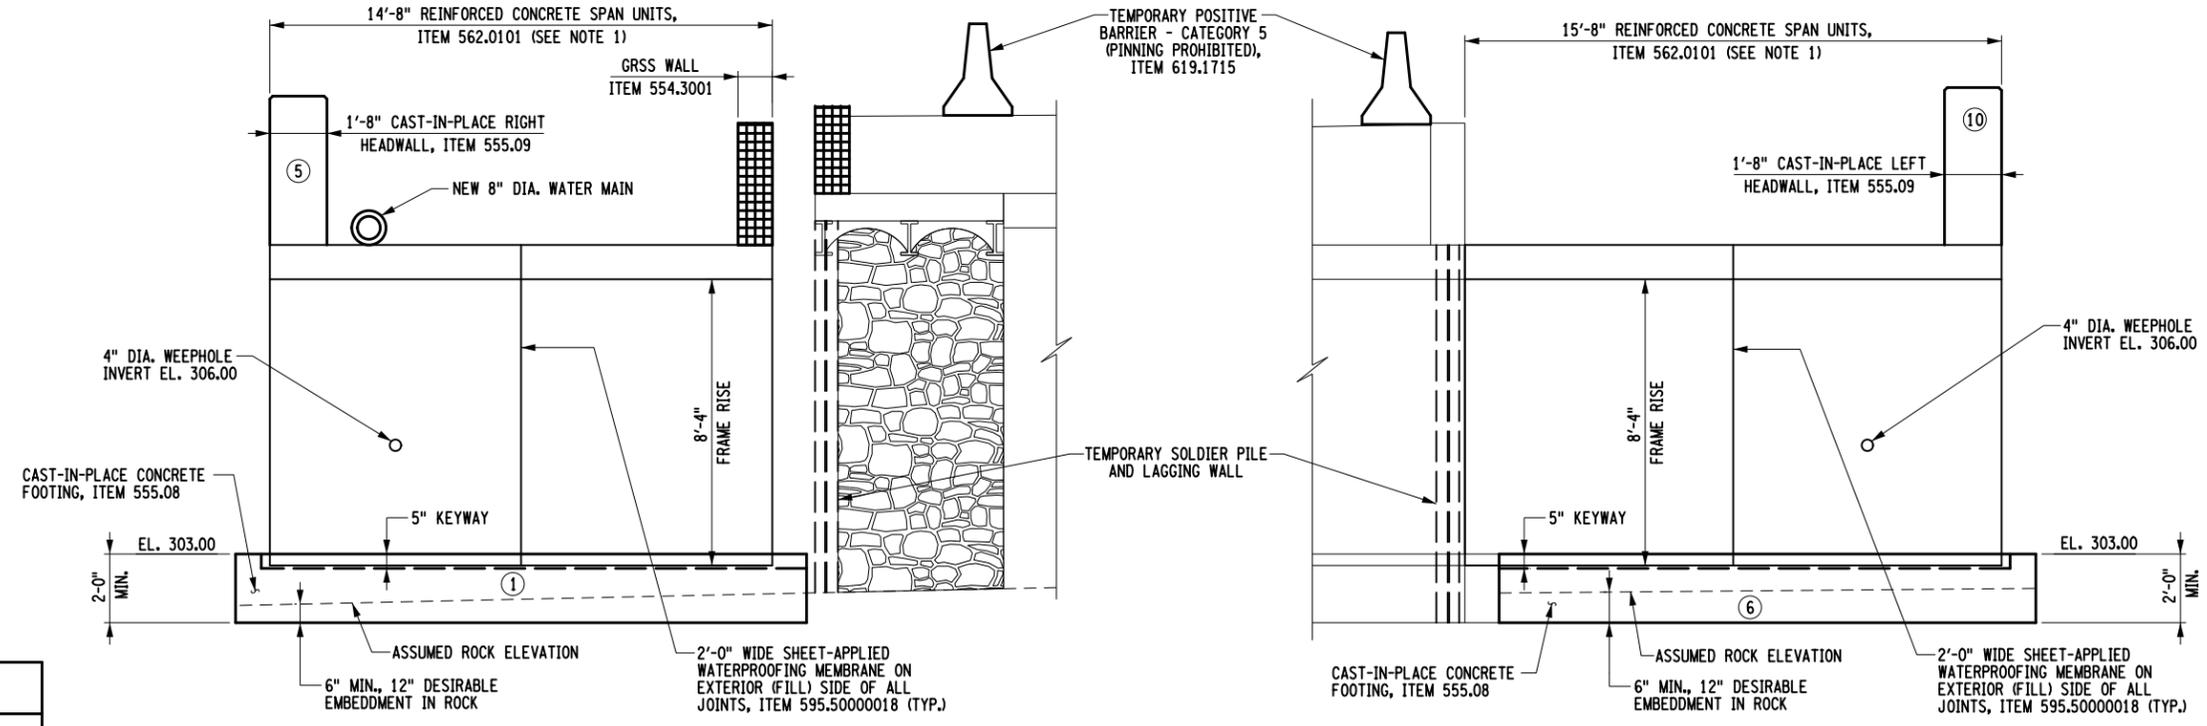

BEGIN ABUTMENT ELEVATION CONSTRUCTION STAGE 1
 SCALE: 3/16"=1'-0"

BEGIN ABUTMENT ELEVATION CONSTRUCTION STAGE 2
 SCALE: 3/16"=1'-0"


AFFIX SEAL: GREENMAN - PEDERSEN, INC
 ON: APRIL 15, 2021

ALTERED BY:
 ON:


AS-BUILT REVISIONS DESCRIPTION OF ALTERATIONS:	VETERAN'S ROAD CULVERT REPLACEMENT	PIN 1761.09	BRIDGES	CULVERTS	ALL DIMENSIONS IN FT UNLESS OTHERWISE NOTED	CONTRACT NUMBER	
	OVER FIVE MILE CREEK					D036296	
	TOWN OF TICONDEROGA					PROPOSED BEGIN ABUTMENT	DRAWING NO. ST-15
	COUNTY: ESSEX					REGION: 1	SHEET NO. 27
IT IS A VIOLATION OF LAW FOR ANY PERSON, UNLESS THEY ARE ACTING UNDER THE DIRECTION OF A LICENSED PROFESSIONAL ENGINEER, ARCHITECT, LANDSCAPE ARCHITECT, OR LAND SURVEYOR, TO ALTER AN ITEM IN ANY WAY. IF AN ITEM BEARING THE STAMP OF A LICENSED PROFESSIONAL IS ALTERED, THE ALTERING ENGINEER, ARCHITECT, LANDSCAPE ARCHITECT, OR LAND SURVEYOR SHALL STAMP THE DOCUMENT AND INCLUDE THE NOTATION "ALTERED BY" FOLLOWED BY THEIR SIGNATURE, THE DATE OF SUCH ALTERATION, AND A SPECIFIC DESCRIPTION OF THE ALTERATION.							

FILE NAME = ...176109_CPB_ABT_BGN_RMF_PLN.dgn
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 USER = skern


DESIGN SUPERVISOR J. SIMKULET
 JOB MANAGER D. THOMAS
 DESIGN S. KERN
 CHECK B. WEAVER
 DRAFTING F. CUOCCIO
 CHECK S. KERN
 PROJECT MANAGER S. KERN

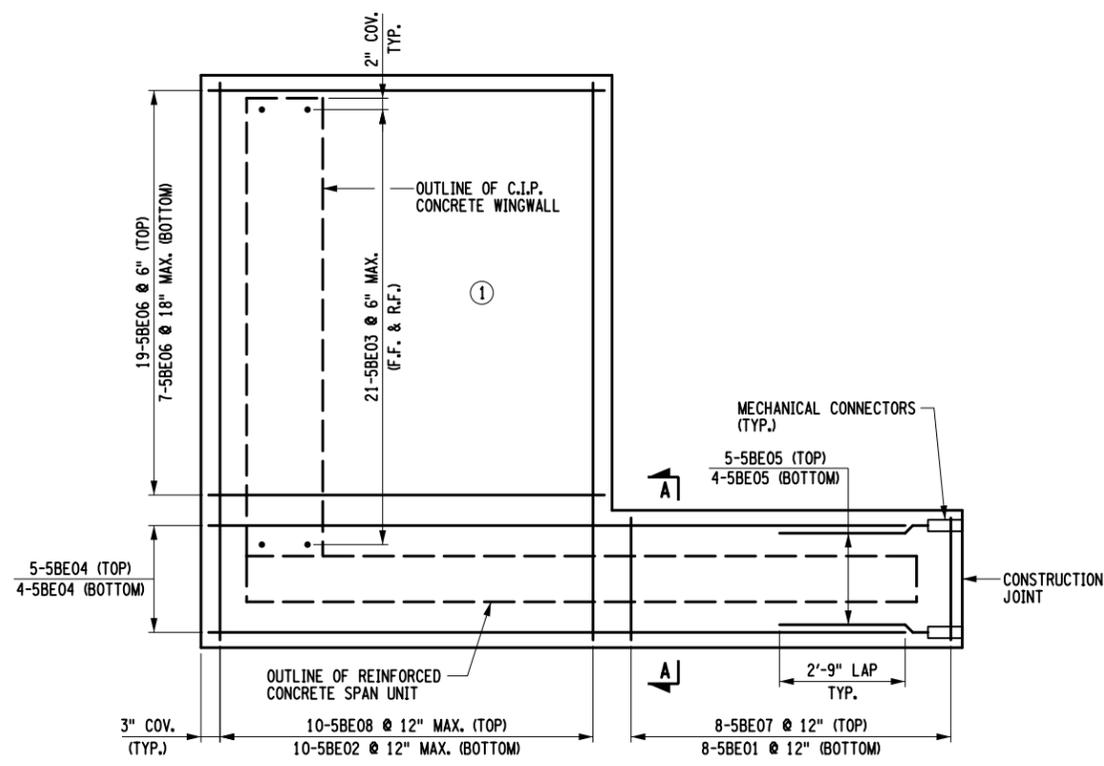


**BEGIN ABUTMENT FOOTING REINFORCEMENT PLAN
 CONSTRUCTION STAGE 1**
 SCALE: 1/4"=1'-0"

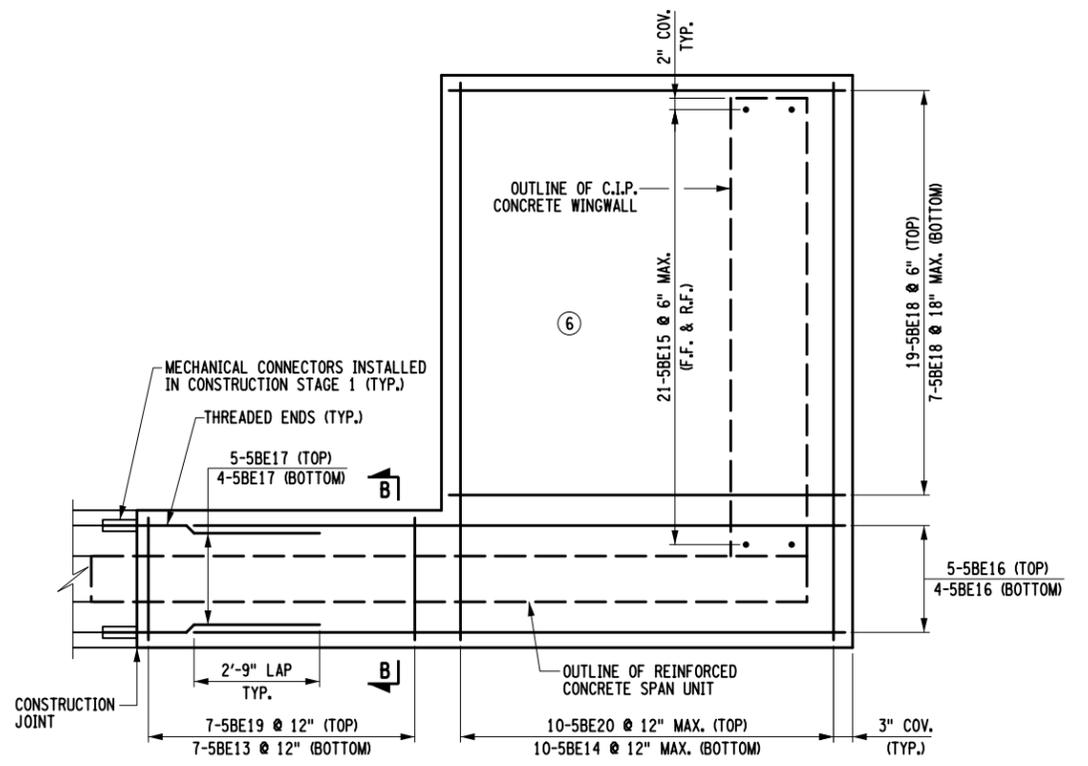

**BEGIN ABUTMENT FOOTING REINFORCEMENT PLAN
 CONSTRUCTION STAGE 2**
 SCALE: 1/4"=1'-0"

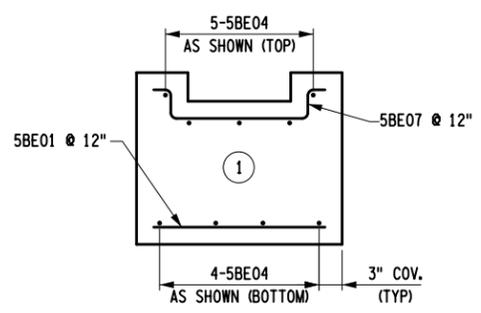

SECTION A-A
 SCALE: 3/8"=1'-0"

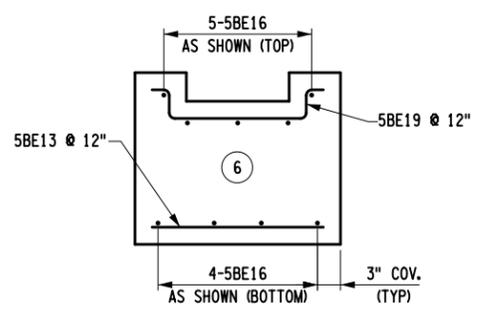

SECTION B-B
 SCALE: 3/8"=1'-0"


NOTES:
 1. ALL REBAR SHOWN IS TO BE PAID FOR UNDER ITEM 556.0202 EXCEPT AS NOTED.

AFFIX SEAL: GREENMAN - PEDERSEN, INC ON: APRIL 15, 2021	ALTERED BY: ON:

AS-BUILT REVISIONS DESCRIPTION OF ALTERATIONS:	VETERAN'S ROAD CULVERT REPLACEMENT OVER FIVE MILE CREEK	PIN 1761.09	BRIDGES	CULVERTS	ALL DIMENSIONS IN FT UNLESS OTHERWISE NOTED	CONTRACT NUMBER D036296
	TOWN OF TICONDEROGA				BEGIN ABUTMENT FOOTING REINFORCEMENT PLAN	DRAWING NO. ST-16 SHEET NO. 28
	COUNTY: ESSEX	REGION: 1				

IT IS A VIOLATION OF LAW FOR ANY PERSON, UNLESS THEY ARE ACTING UNDER THE DIRECTION OF A LICENSED PROFESSIONAL ENGINEER, ARCHITECT, LANDSCAPE ARCHITECT, OR LAND SURVEYOR, TO ALTER AN ITEM IN ANY WAY. IF AN ITEM BEARING THE STAMP OF A LICENSED PROFESSIONAL IS ALTERED, THE ALTERING ENGINEER, ARCHITECT, LANDSCAPE ARCHITECT, OR LAND SURVEYOR SHALL STAMP THE DOCUMENT AND INCLUDE THE NOTATION "ALTERED BY" FOLLOWED BY THEIR SIGNATURE, THE DATE OF SUCH ALTERATION, AND A SPECIFIC DESCRIPTION OF THE ALTERATION.


PROJECT MANAGER S. KERN
 CHECK S. KERN
 DRAFTING F. CIUCCIO
 CHECK B. WEAVER
 DESIGN S. KERN
 JOB MANAGER D. THOMAS
 DESIGN SUPERVISOR J. SIMKULET

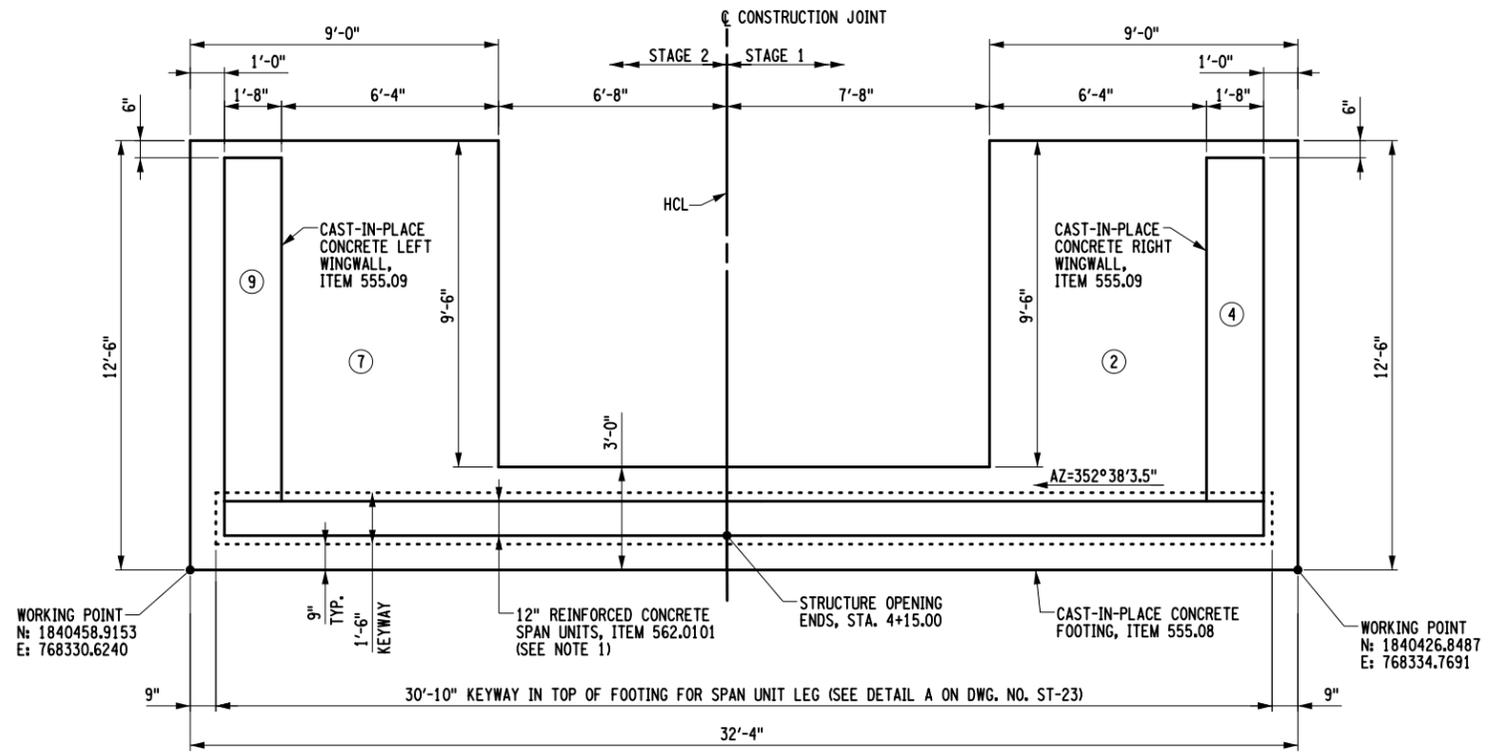


END ABUTMENT PLAN
 SCALE: 3/16"=1'-0"

NOTES:

- THE NUMBER AND SIZE OF REINFORCED CONCRETE SPAN UNITS ARE ARBITRARILY SHOWN. ACTUAL NUMBER AND DIMENSIONS OF CONCRETE UNITS SHALL BE IN ACCORDANCE WITH CONTRACTOR'S APPROVED DESIGN CALCULATIONS AND SHOP DRAWINGS.
- ADHERE TO THE FOLLOWING PROCEDURES:
 - IF THE ROCK SURFACE IS WITHIN 2 FEET OF EL. 301.00, ADHERE TO THE FOLLOWING:
 - IF THE ROCK SURFACE IS HIGHER, REMOVE THE ROCK SO THAT THE MINIMUM FOOTING THICKNESS OF 2 FEET CAN BE MAINTAINED.
 - IF THE ROCK SURFACE IS LOWER, PLACE ADDITIONAL CONCRETE SO THAT THE TOP OF FOOTING EL. 303.00 CAN BE MAINTAINED.
 - IF THE ROCK SURFACE IS MORE THAN 2 FEET FROM EL. 301.00, THE RESIDENT ENGINEER WILL NOTIFY THE ENGINEER OF THIS CONDITION. THE ENGINEER WILL DETERMINE IF: THE FOUNDATION FOR THE SUBSTRUCTURE HAS TO BE REDESIGNED, ADDITIONAL FOOTING CONCRETE HAS TO BE PLACED, OR ADDITIONAL ROCK HAS TO BE EXCAVATED.
- A FOOTING THICKNESS OF 3'-0" IS ASSUMED FOR ESTIMATING PURPOSES.

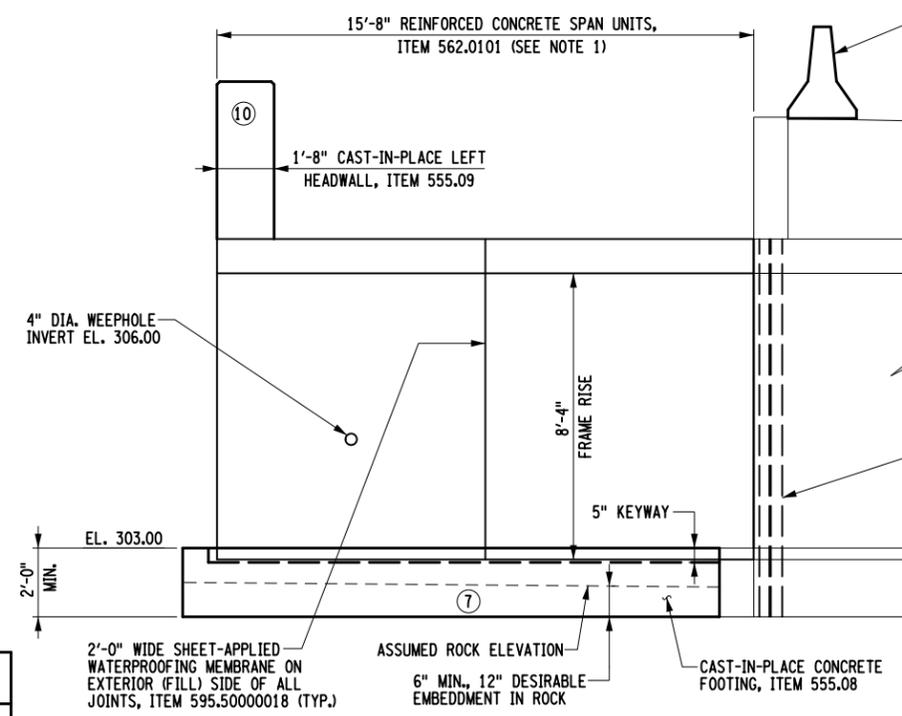

END ABUTMENT ELEVATION CONSTRUCTION STAGE 2
 SCALE: 3/16"=1'-0"

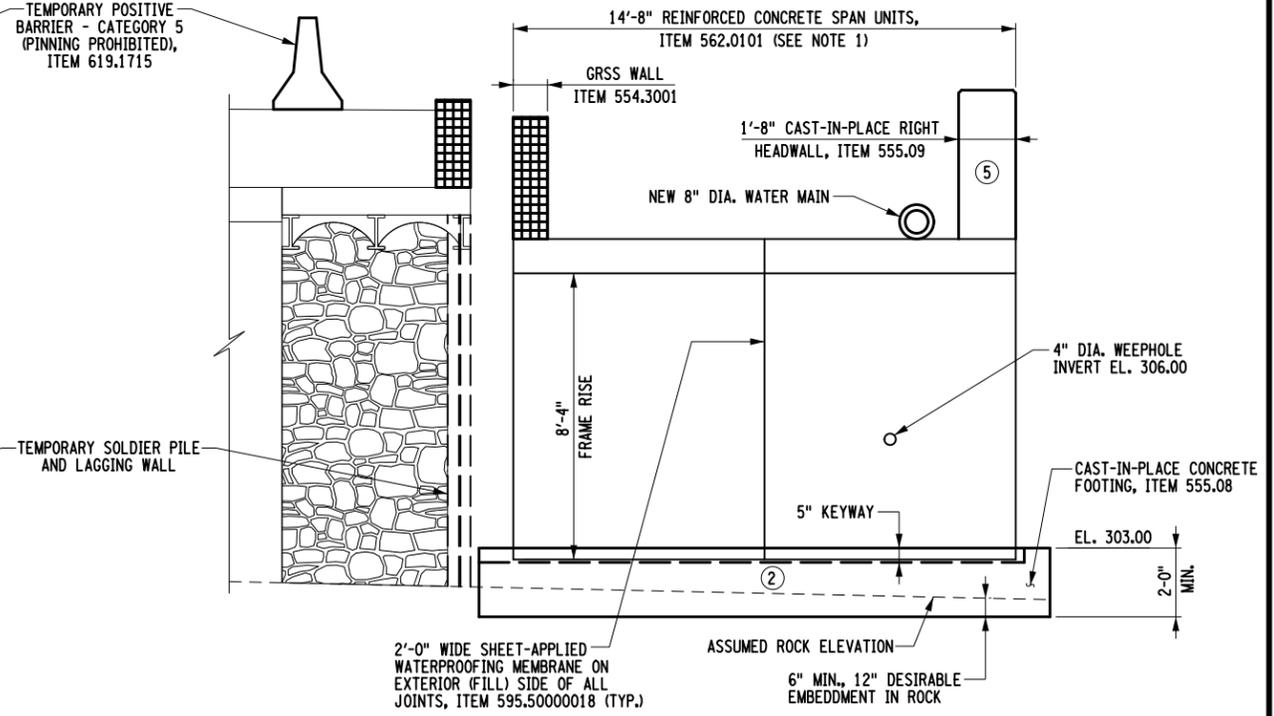

END ABUTMENT ELEVATION CONSTRUCTION STAGE 1
 SCALE: 3/16"=1'-0"

AFFIX SEAL: GREENMAN - PEDERSEN, INC
 ON: APRIL 15, 2021
 ALTERED BY:
 ON:




AS-BUILT REVISIONS DESCRIPTION OF ALTERATIONS:	VETERAN'S ROAD CULVERT REPLACEMENT	PIN 1761.09	BRIDGES	CULVERTS	ALL DIMENSIONS IN FT UNLESS OTHERWISE NOTED	CONTRACT NUMBER	
	OVER FIVE MILE CREEK					D036296	
	TOWN OF TICONDEROGA				PROPOSED END ABUTMENT	DRAWING NO. ST-17	
	COUNTY: ESSEX	REGION: 1				SHEET NO. 29	
IT IS A VIOLATION OF LAW FOR ANY PERSON, UNLESS THEY ARE ACTING UNDER THE DIRECTION OF A LICENSED PROFESSIONAL ENGINEER, ARCHITECT, LANDSCAPE ARCHITECT, OR LAND SURVEYOR, TO ALTER AN ITEM IN ANY WAY. IF AN ITEM BEARING THE STAMP OF A LICENSED PROFESSIONAL IS ALTERED, THE ALTERING ENGINEER, ARCHITECT, LANDSCAPE ARCHITECT, OR LAND SURVEYOR SHALL STAMP THE DOCUMENT AND INCLUDE THE NOTATION "ALTERED BY" FOLLOWED BY THEIR SIGNATURE, THE DATE OF SUCH ALTERATION, AND A SPECIFIC DESCRIPTION OF THE ALTERATION.							


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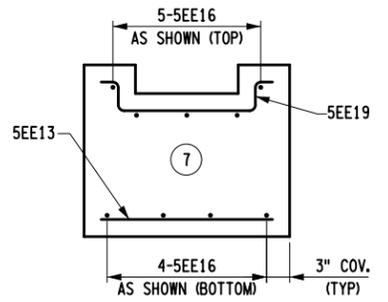
DESIGN SUPERVISOR J. SIMKULET
 JOB MANAGER D. THOMAS
 DESIGN S. KERN
 CHECK B. WEAVER
 DRAFTING F. CUOCCIO
 CHECK S. KERN
 PROJECT MANAGER S. KERN




**END ABUTMENT FOOTING REINFORCEMENT PLAN
 CONSTRUCTION STAGE 2**
 SCALE: 1/4"=1'-0"

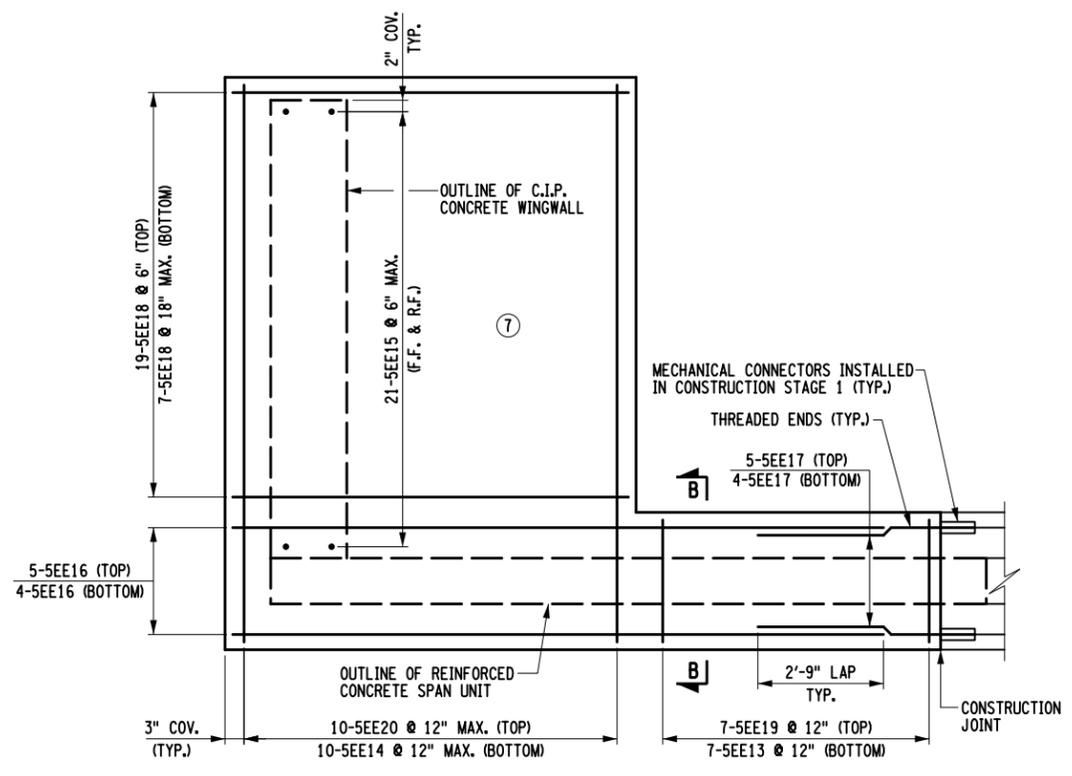

**END ABUTMENT FOOTING REINFORCEMENT PLAN
 CONSTRUCTION STAGE 1**
 SCALE: 1/4"=1'-0"

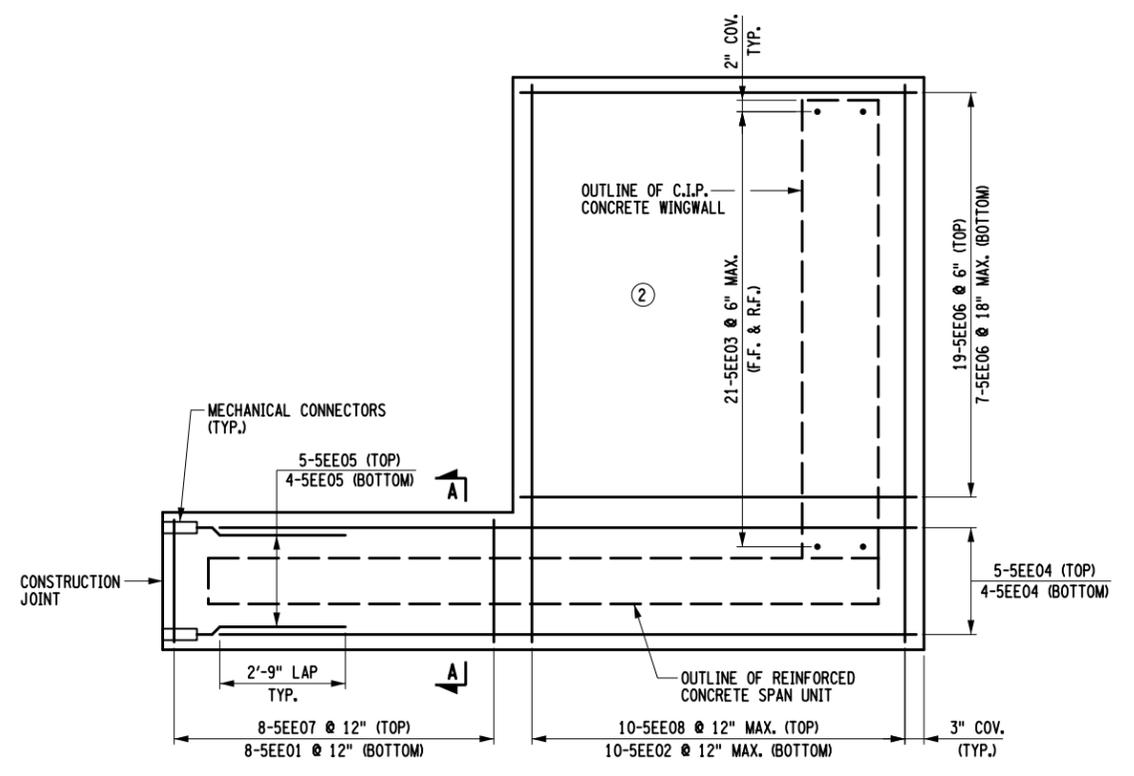

SECTION B-B
 SCALE: 3/8"=1'-0"

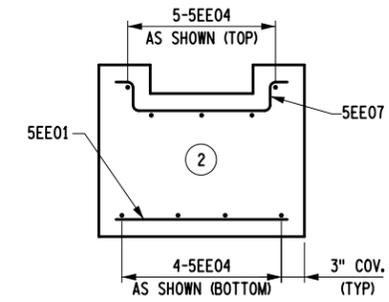

SECTION A-A
 SCALE: 3/8"=1'-0"

NOTES:
 1. ALL REBAR SHOWN IS TO BE PAID FOR UNDER ITEM 556.0202 EXCEPT AS NOTED.



AFFIX SEAL: GREENMAN - PEDERSEN, INC
 ON: APRIL 15, 2021
 ALTERED BY:
 ON:



AS-BUILT REVISIONS DESCRIPTION OF ALTERATIONS:	VETERAN'S ROAD CULVERT REPLACEMENT	PIN 1761.09	BRIDGES	CULVERTS	ALL DIMENSIONS IN FT UNLESS OTHERWISE NOTED	CONTRACT NUMBER D036296
	OVER FIVE MILE CREEK					END ABUTMENT FOOTING REINFORCEMENT PLAN
TOWN OF TICONDEROGA						
COUNTY: ESSEX REGION: 1						

IT IS A VIOLATION OF LAW FOR ANY PERSON, UNLESS THEY ARE ACTING UNDER THE DIRECTION OF A LICENSED PROFESSIONAL ENGINEER, ARCHITECT, LANDSCAPE ARCHITECT, OR LAND SURVEYOR, TO ALTER AN ITEM IN ANY WAY. IF AN ITEM BEARING THE STAMP OF A LICENSED PROFESSIONAL IS ALTERED, THE ALTERING ENGINEER, ARCHITECT, LANDSCAPE ARCHITECT, OR LAND SURVEYOR SHALL STAMP THE DOCUMENT AND INCLUDE THE NOTATION "ALTERED BY" FOLLOWED BY THEIR SIGNATURE, THE DATE OF SUCH ALTERATION, AND A SPECIFIC DESCRIPTION OF THE ALTERATION.

CONCRETE TABLE		
PLACEMENT	QUANTITY	ITEM NO.
CONSTRUCTION STAGE 1		
1	15.1 CY	555.08
2	15.1 CY	555.08
3	8.3 CY	555.09
4	8.1 CY	555.09
5	4.5 CY	555.09
CONSTRUCTION STAGE 2		
6	14.7 CY	555.08
7	14.7 CY	555.08
8	8.5 CY	555.09
9	8.3 CY	555.09
10	4.8 CY	555.09

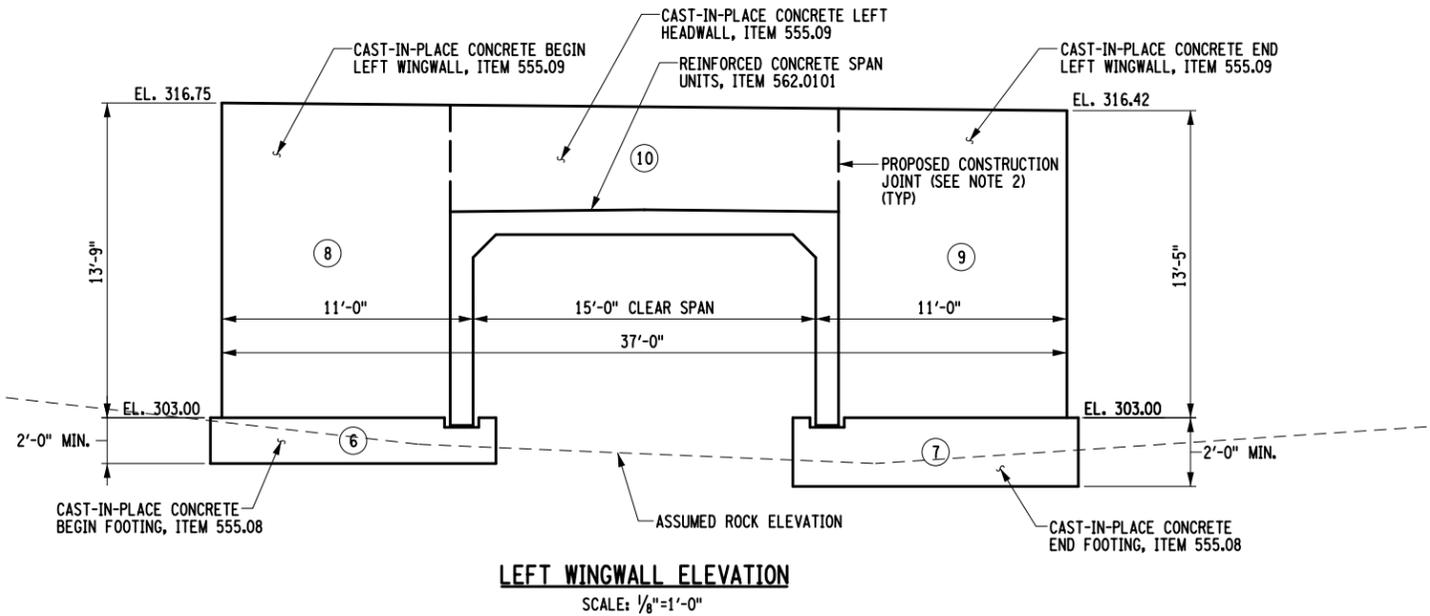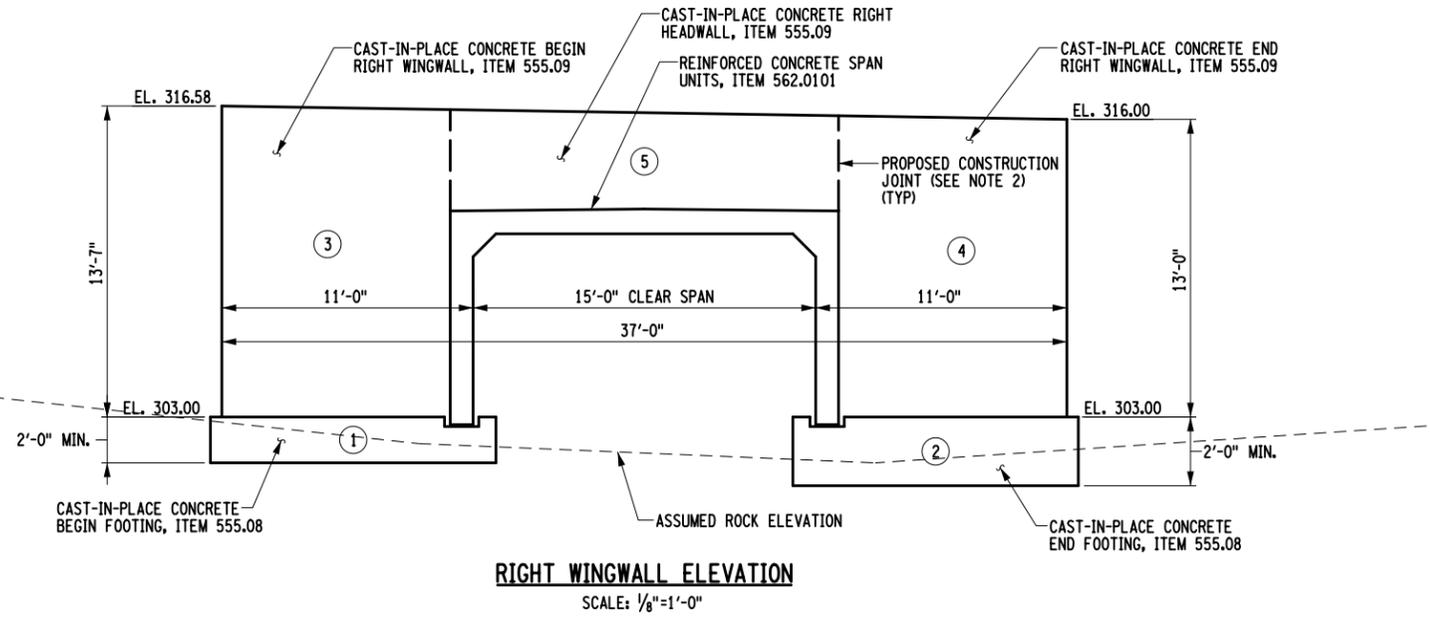

- NOTES:**
- ADHERE TO THE FOLLOWING PROCEDURES:
 - IF THE ROCK SURFACE IS WITHIN 2 FEET OF EL. 301.00, ADHERE TO THE FOLLOWING:
 - IF THE ROCK SURFACE IS HIGHER, REMOVE THE ROCK SO THAT THE MINIMUM FOOTING THICKNESS OF 2 FEET CAN BE MAINTAINED.
 - IF THE ROCK SURFACE IS LOWER, PLACE ADDITIONAL CONCRETE SO THAT THE TOP OF FOOTING EL. 303.00 CAN BE MAINTAINED.
 - IF THE ROCK SURFACE IS MORE THAN 2 FEET FROM EL. 301.00, THE RESIDENT ENGINEER WILL NOTIFY THE ENGINEER OF THIS CONDITION. THE ENGINEER WILL DETERMINE IF: THE FOUNDATION FOR THE SUBSTRUCTURE HAS TO BE REDESIGNED, ADDITIONAL FOOTING CONCRETE HAS TO BE PLACED, OR ADDITIONAL ROCK HAS TO BE EXCAVATED.
 - THE CONSTRUCTION JOINT BETWEEN THE WINGWALLS AND HEADWALLS MAY BE ELIMINATED IF THEY ARE POURED SIMULTANEOUSLY.
 - A FOOTING THICKNESS OF 3'-0" IS ASSUMED FOR ESTIMATING PURPOSES.

AFFIX SEAL: GREENMAN - PEDERSEN, INC
ON: APRIL 15, 2021

ALTERED BY:
ON:



AS-BUILT REVISIONS DESCRIPTION OF ALTERATIONS:	VETERAN'S ROAD CULVERT REPLACEMENT	PIN 1761.09	BRIDGES	CULVERTS	ALL DIMENSIONS IN ft UNLESS OTHERWISE NOTED	CONTRACT NUMBER D036296
	OVER FIVE MILE CREEK					DRAWING NO. ST-19 SHEET NO. 31
	TOWN OF TICONDEROGA				PROPOSED WINGWALL ELEVATIONS	GPI GREENMAN-PEDERSEN, INC. CONSULTING ENGINEERS
	COUNTY: ESSEX	REGION: 1				


IT IS A VIOLATION OF LAW FOR ANY PERSON, UNLESS THEY ARE ACTING UNDER THE DIRECTION OF A LICENSED PROFESSIONAL ENGINEER, ARCHITECT, LANDSCAPE ARCHITECT, OR LAND SURVEYOR, TO ALTER AN ITEM IN ANY WAY. IF AN ITEM BEARING THE STAMP OF A LICENSED PROFESSIONAL IS ALTERED, THE ALTERING ENGINEER, ARCHITECT, LANDSCAPE ARCHITECT, OR LAND SURVEYOR SHALL STAMP THE DOCUMENT AND INCLUDE THE NOTATION "ALTERED BY" FOLLOWED BY THEIR SIGNATURE, THE DATE OF SUCH ALTERATION, AND A SPECIFIC DESCRIPTION OF THE ALTERATION.

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USER = skern


PROJECT MANAGER: S. KERN
CHECK: S. KERN
DRAFTING: F. CIUCCIO
CHECK: B. WEAVER
DESIGN: S. KERN
JOB MANAGER: D. THOMAS
DESIGN SUPERVISOR: J. SIMKULET

FILE NAME = ...\\176109_CPB_WW_RT_RNF_DTL.dgn
 DATE/TIME = 4/15/2021
 USER = skern


DESIGN SUPERVISOR J. SIMKULET
 JOB MANAGER D. THOMAS
 DESIGN S. KERN
 CHECK B. WEAVER
 DRAFTING F. CUOCCIO
 CHECK S. KERN
 PROJECT MANAGER S. KERN

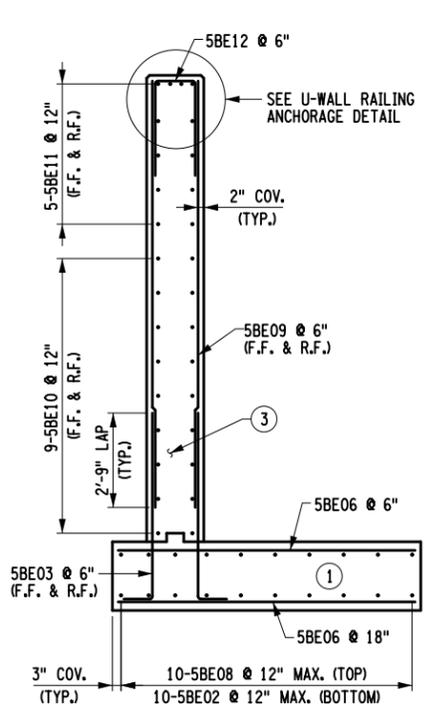


SECTION A-A
 SCALE: 3/16"=1'-0"

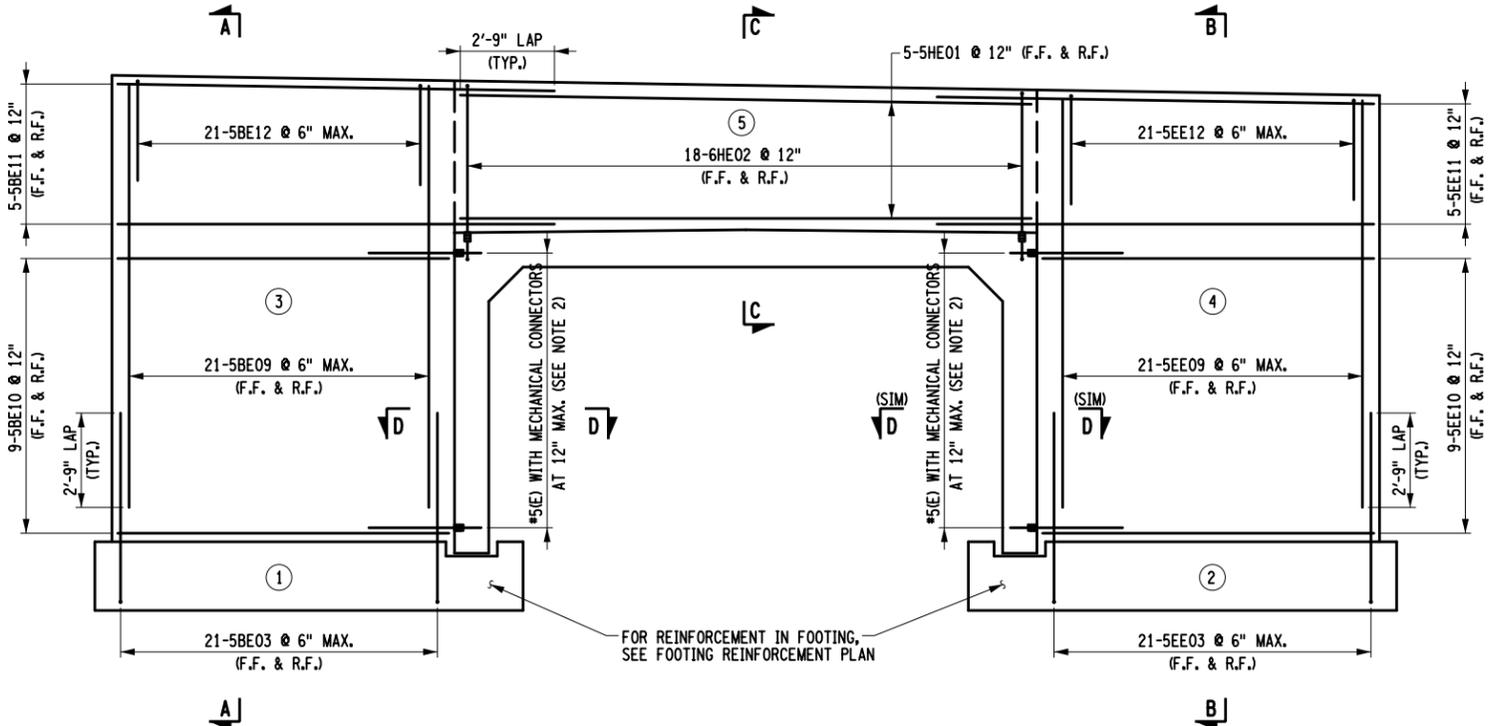

RIGHT WINGWALL REINFORCEMENT ELEVATION
 SCALE: 3/16"=1'-0"

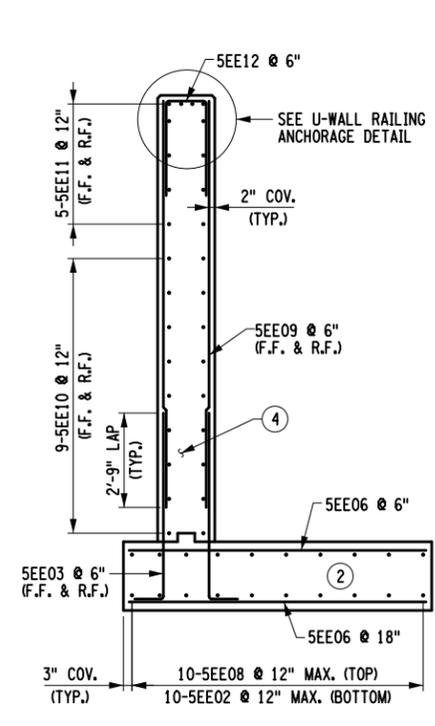


SECTION B-B
 SCALE: 3/16"=1'-0"

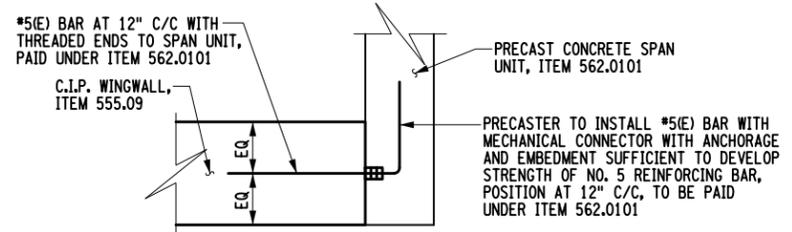


SECTION D-D
 SCALE: 3/16"=1'-0"

- NOTES:**
- ALL REBAR SHOWN IS TO BE PAID UNDER ITEM 556.0202 EXCEPT AS NOTED.
 - PRECASTER TO INSTALL #5(E) BAR WITH MECHANICAL CONNECTOR WITH ANCHORAGE AND EMBEDMENT SUFFICIENT TO DEVELOP STRENGTH OF NO. 5 REINFORCING BAR. POSITION AT 12" CENTER-ON-CENTER. MECHANICAL CONNECTOR WITH THREADED INSERT TO BE PAID UNDER ITEM 562.0101.
 - HEADWALL REINFORCEMENT IS TO BE PAID UNDER ITEM 556.0202 EXCEPT THE #6(E) BAR WITH MECHANICAL CONNECTOR EMBEDDED IN THE PRECAST CONCRETE SPAN UNITS TO BE PAID UNDER ITEM 562.0101.

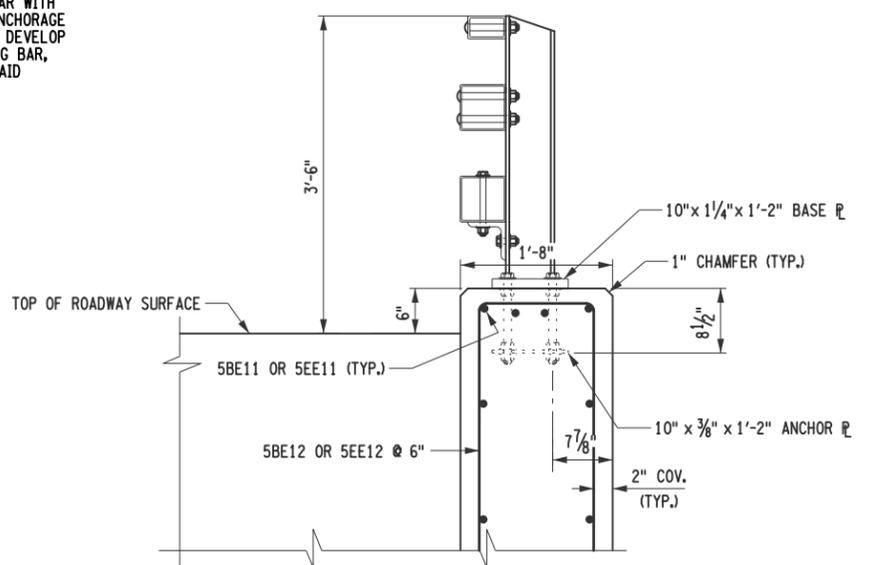

U-WALL RAILING ANCHORAGE DETAIL
 NOT TO SCALE

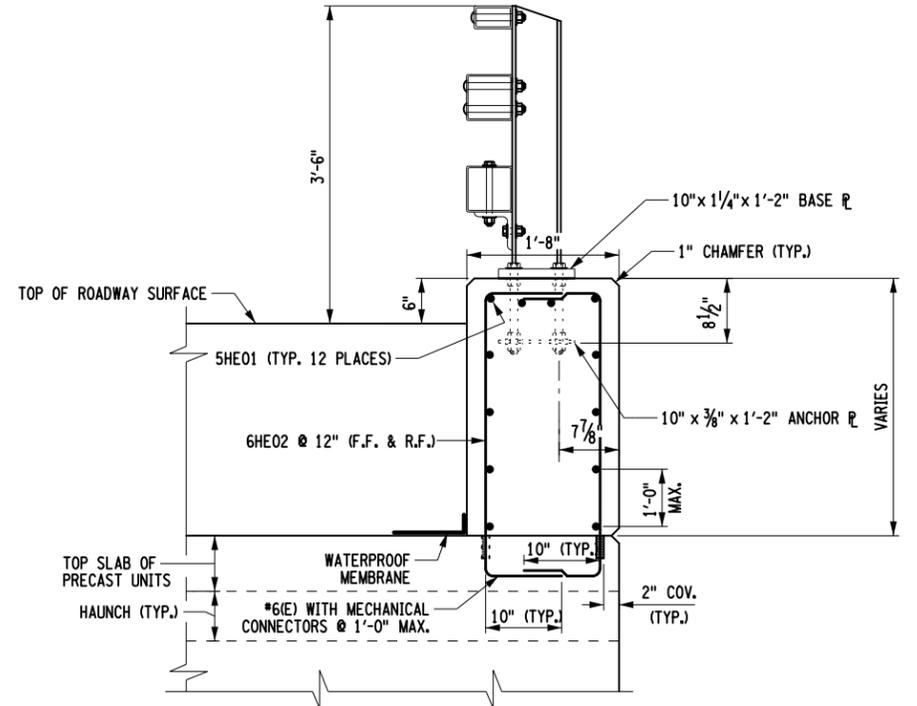

SECTION C-C
 NOT TO SCALE


AFFIX SEAL: GREENMAN - PEDERSEN, INC
 ON: APRIL 15, 2021

ALTERED BY:
 ON:


AS-BUILT REVISIONS DESCRIPTION OF ALTERATIONS:	VETERAN'S ROAD CULVERT REPLACEMENT	PIN 1761.09	BRIDGES	CULVERTS	ALL DIMENSIONS IN FT UNLESS OTHERWISE NOTED	CONTRACT NUMBER D036296	
	OVER FIVE MILE CREEK					RIGHT WINGWALL REINFORCEMENT DETAILS	DRAWING NO. ST-20 SHEET NO. 32
	TOWN OF TICONDEROGA						
	COUNTY: ESSEX	REGION: 1					
IT IS A VIOLATION OF LAW FOR ANY PERSON, UNLESS THEY ARE ACTING UNDER THE DIRECTION OF A LICENSED PROFESSIONAL ENGINEER, ARCHITECT, LANDSCAPE ARCHITECT, OR LAND SURVEYOR, TO ALTER AN ITEM IN ANY WAY. IF AN ITEM BEARING THE STAMP OF A LICENSED PROFESSIONAL IS ALTERED, THE ALTERING ENGINEER, ARCHITECT, LANDSCAPE ARCHITECT, OR LAND SURVEYOR SHALL STAMP THE DOCUMENT AND INCLUDE THE NOTATION "ALTERED BY" FOLLOWED BY THEIR SIGNATURE, THE DATE OF SUCH ALTERATION, AND A SPECIFIC DESCRIPTION OF THE ALTERATION.							

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 DATE/TIME = 4/15/2021
 USER = skern


DESIGN SUPERVISOR J. SIMKULET
 JOB MANAGER D. THOMAS
 DESIGN S. KERN
 CHECK B. WEAVER
 DRAFTING F. CUOCCIO
 CHECK S. KERN
 PROJECT MANAGER S. KERN

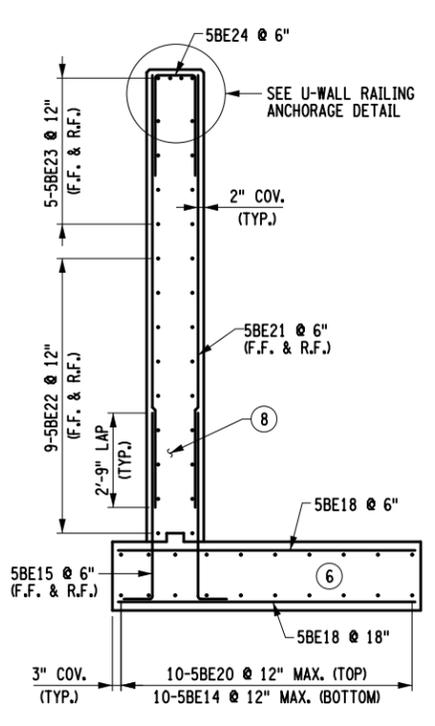


SECTION A-A
 SCALE: 3/16"=1'-0"

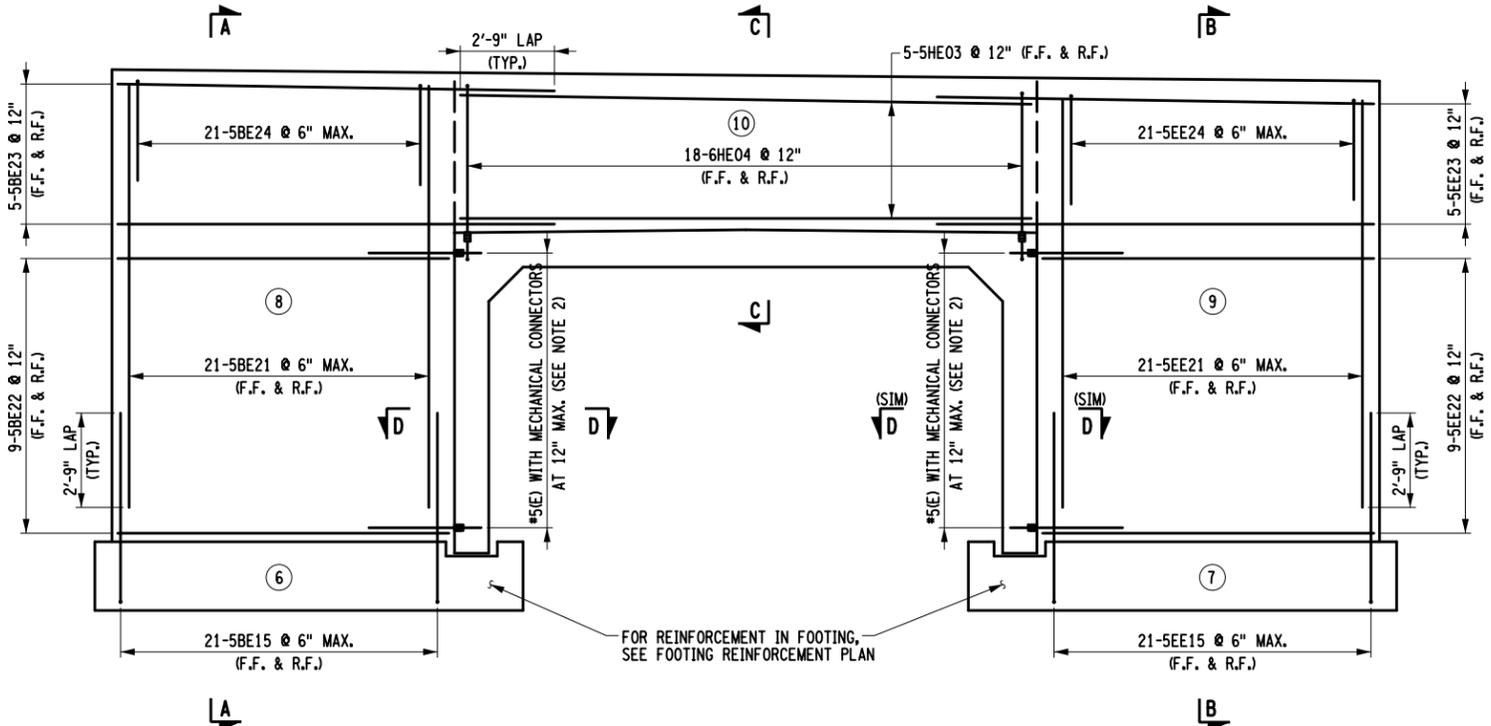

LEFT WINGWALL REINFORCEMENT ELEVATION
 SCALE: 3/16"=1'-0"

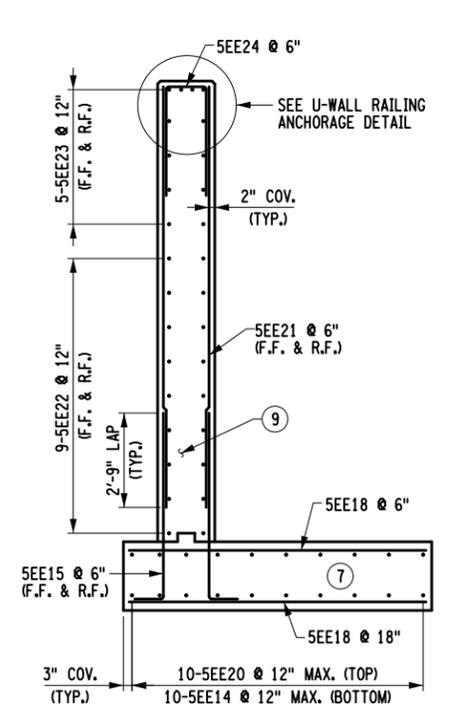


SECTION B-B
 SCALE: 3/16"=1'-0"

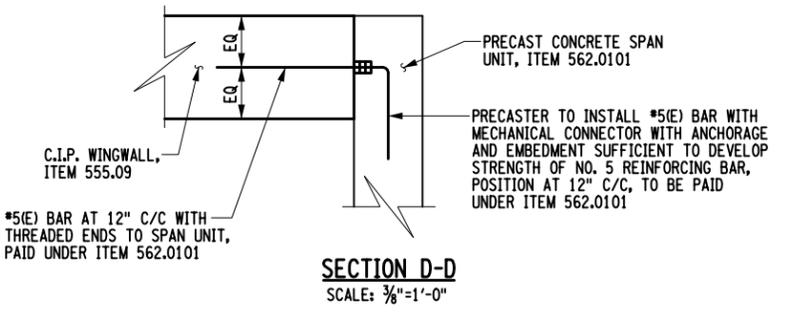


SECTION D-D
 SCALE: 3/16"=1'-0"

- NOTES:**
- ALL REBAR SHOWN IS TO BE PAID UNDER ITEM 556.0202 EXCEPT AS NOTED.
 - PRECASTER TO INSTALL #5(E) BAR WITH MECHANICAL CONNECTOR WITH ANCHORAGE AND EMBEDMENT SUFFICIENT TO DEVELOP STRENGTH OF NO. 5 REINFORCING BAR. POSITION AT 12" CENTER-ON-CENTER. MECHANICAL CONNECTOR WITH THREADED INSERT TO BE PAID UNDER ITEM 562.0101.
 - HEADWALL REINFORCEMENT IS TO BE PAID UNDER ITEM 556.0202 EXCEPT THE #6(E) BAR WITH MECHANICAL CONNECTOR EMBEDDED IN THE PRECAST CONCRETE SPAN UNITS TO BE PAID UNDER ITEM 562.0101.

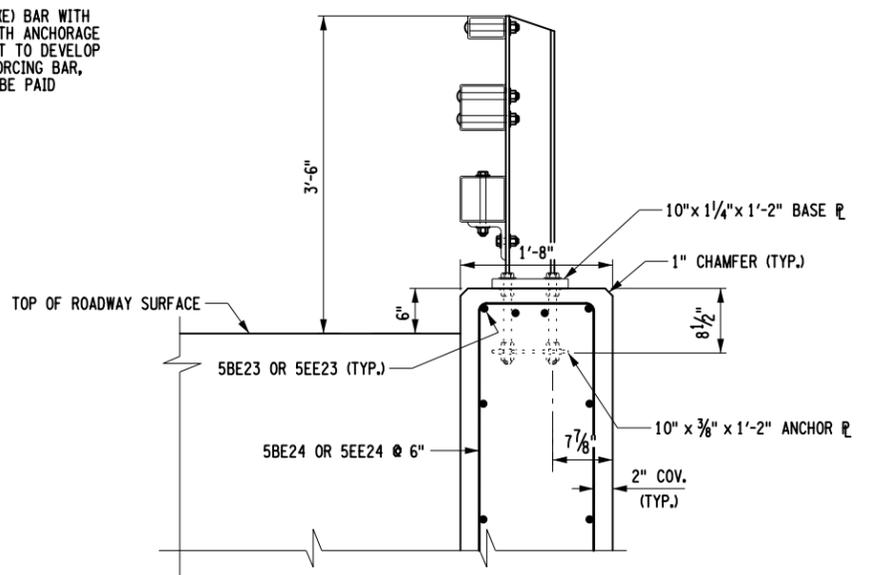

U-WALL RAILING ANCHORAGE DETAIL
 NOT TO SCALE

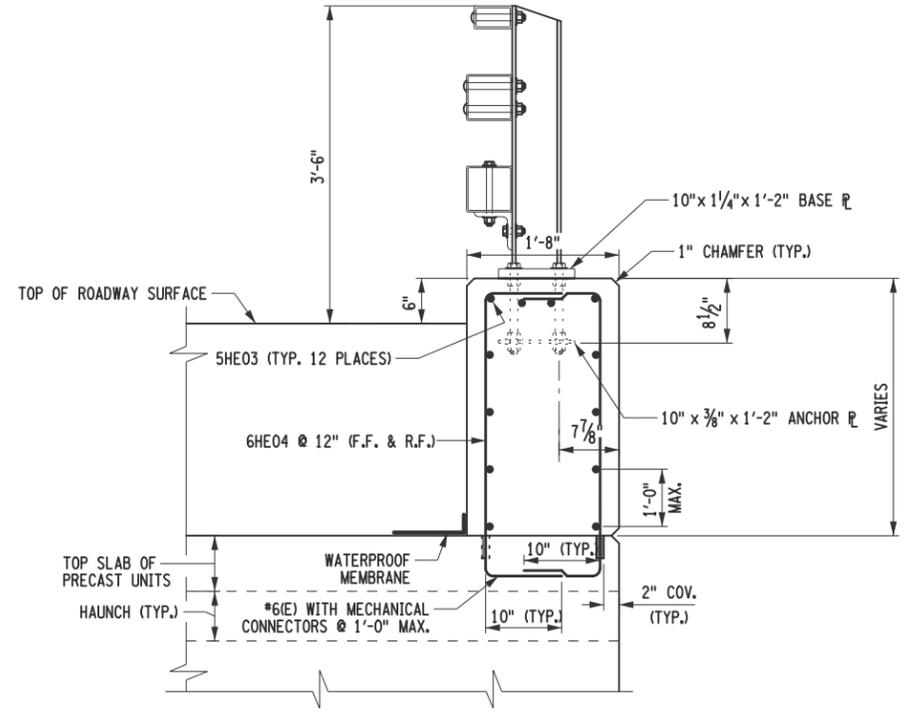

SECTION C-C
 NOT TO SCALE

AFFIX SEAL: GREENMAN - PEDERSEN, INC
 ON: APRIL 15, 2021



ALTERED BY:
 ON:

AS-BUILT REVISIONS DESCRIPTION OF ALTERATIONS:	VETERAN'S ROAD CULVERT REPLACEMENT	PIN 1761.09	BRIDGES	CULVERTS	ALL DIMENSIONS IN FT UNLESS OTHERWISE NOTED	CONTRACT NUMBER D036296
	OVER FIVE MILE CREEK					LEFT WINGWALL REINFORCEMENT DETAILS
TOWN OF TICONDEROGA		REGION: 1			GPI GREENMAN-PEDERSEN, INC. CONSULTING ENGINEERS	TOWN OF TICONDEROGA
COUNTY: ESSEX						

IT IS A VIOLATION OF LAW FOR ANY PERSON, UNLESS THEY ARE ACTING UNDER THE DIRECTION OF A LICENSED PROFESSIONAL ENGINEER, ARCHITECT, LANDSCAPE ARCHITECT, OR LAND SURVEYOR, TO ALTER AN ITEM IN ANY WAY. IF AN ITEM BEARING THE STAMP OF A LICENSED PROFESSIONAL IS ALTERED, THE ALTERING ENGINEER, ARCHITECT, LANDSCAPE ARCHITECT, OR LAND SURVEYOR SHALL STAMP THE DOCUMENT AND INCLUDE THE NOTATION "ALTERED BY" FOLLOWED BY THEIR SIGNATURE, THE DATE OF SUCH ALTERATION, AND A SPECIFIC DESCRIPTION OF THE ALTERATION.

PROJECT MANAGER S. KERN
 CHECK S. KERN
 DRAFTING F. CIUCCIO
 CHECK B. WEAVER
 DESIGN S. KERN
 JOB MANAGER D. THOMAS
 DESIGN SUPERVISOR J. SIMKULET

LOAD RATING (LFD)		
INVENTORY	HS	TONS
OPERATING	HS	TONS
LOAD RATING (LRFD)		
INVENTORY	HL-93	
OPERATING	HL-93	

(TABLE TO BE FILLED OUT BY E.I.C.)


ASSUMED UNFACTORED SPAN UNIT REACTIONS		
VERTICAL kip/ft.	DC	2.53
	DW	0.16
	LL	7.69
HORIZONTAL kip/ft.	DC	0.22
	DW	0.03
	LL	0.92
	EH	2.29

DOES NOT INCLUDE SELF WEIGHT OF FOOTING

THREE SIDED STRUCTURE DESIGN DATA	
CLEAR SPAN, ft.	15
CLEAR RISE, ft.	8
* MIN. FILL HEIGHT, ft.	3.54
* MAX. FILL HEIGHT, ft.	4.28
SKEW TO ROADWAY, DEG	0
LIVE LOAD	HL-93
RAILING/BARRIER TEST LOAD	TL-4

* BASED ON ASSUMED SLAB THICKNESS OF 1'-0".
 FABRICATOR SHALL ADJUST BASED ON ACTUAL TOP SLAB THICKNESS

GEOTECHNICAL DESIGN DATA						
FRICION ANGLE OF SOIL RETAINED BY THE WALL (DEGREES)	FRICION ANGLE OF FOUNDATION SOIL (DEGREES)	TOTAL SOIL UNIT WEIGHT (lb/ft ³)	MAXIMUM SERVICE LIMIT STATE BEARING RESISTANCE (lb/ft ²)	NORMAL COEFFICIENT OF FRICTION FOR SLIDING	STRENGTH LIMIT STATE RESISTANCE FACTOR FOR SLIDING	STRENGTH LIMIT STATE RESISTANCE FACTOR FOR BEARING
35	35	125	160	0.65	0.8	0.45

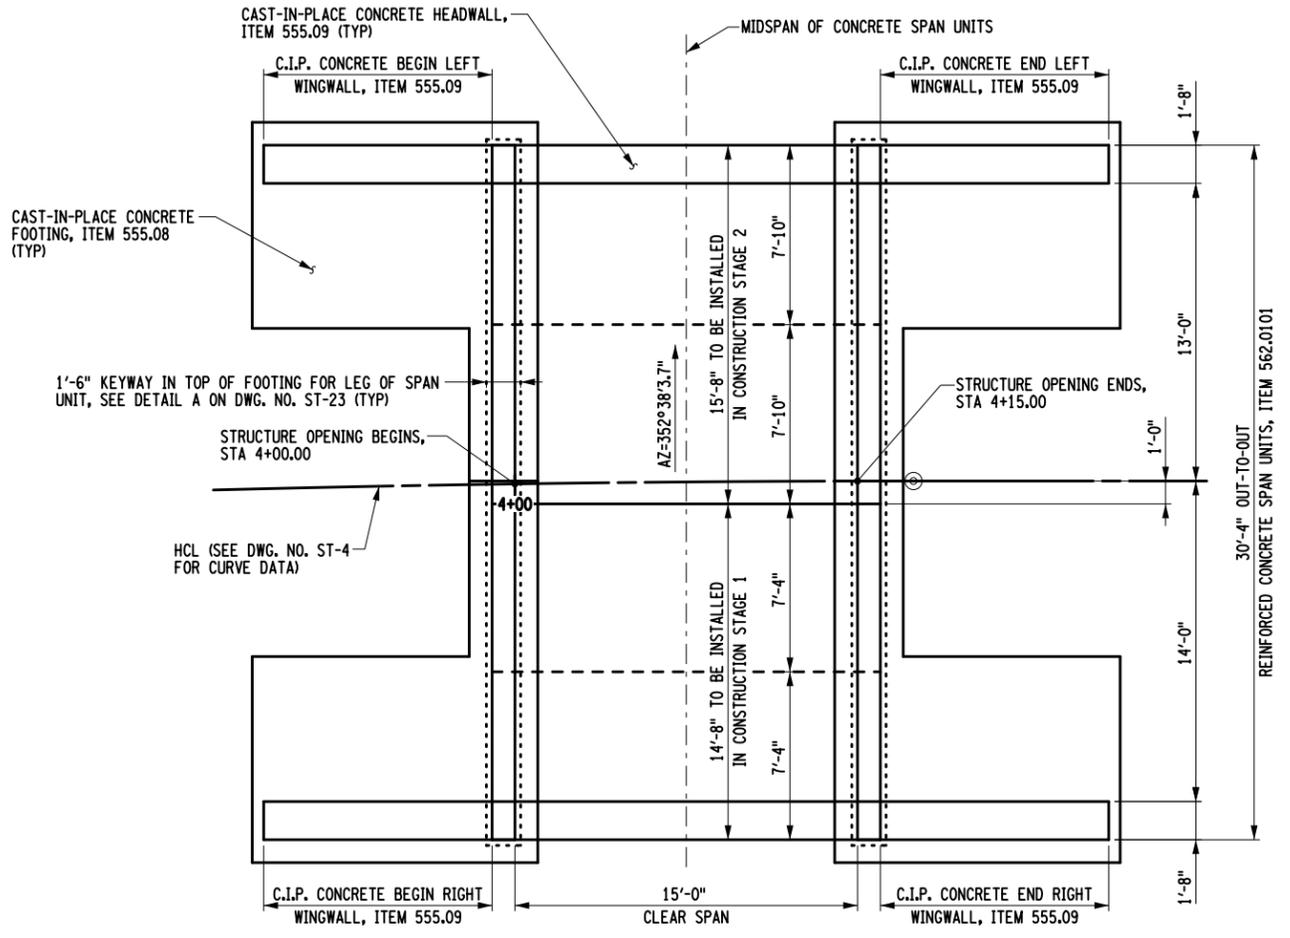

PROPOSED FRAMING PLAN

SCALE: 1/8"=1'-0"



FILE NAME = ... \CADD\176109_CPB_FRM_PLN.dgn
 DATE/TIME = 4/15/2021
 USER = skern

AFFIX SEAL: GREENMAN - PEDERSEN, INC
 ON: APRIL 15, 2021

ALTERED BY:
 ON:



NOTES:


- THE REINFORCED CONCRETE UNIT LAYOUT SHOWN IS PROPOSED. ACTUAL NUMBER AND WIDTH OF CONCRETE UNITS SHALL BE IN ACCORDANCE WITH CONTRACTOR'S APPROVED DESIGN CALCULATIONS AND SHOP DRAWINGS.

AS-BUILT REVISIONS DESCRIPTION OF ALTERATIONS:	VETERAN'S ROAD CULVERT REPLACEMENT	PIN 1761.09	BRIDGES	CULVERTS	ALL DIMENSIONS IN ft UNLESS OTHERWISE NOTED	CONTRACT NUMBER D036296
	OVER FIVE MILE CREEK					THREE SIDED STRUCTURE FRAMING PLAN
	TOWN OF TICONDEROGA	COUNTY: ESSEX	REGION: 1			GPI GREENMAN-PEDERSEN, INC. CONSULTING ENGINEERS

IT IS A VIOLATION OF LAW FOR ANY PERSON, UNLESS THEY ARE ACTING UNDER THE DIRECTION OF A LICENSED PROFESSIONAL ENGINEER, ARCHITECT, LANDSCAPE ARCHITECT, OR LAND SURVEYOR, TO ALTER AN ITEM IN ANY WAY. IF AN ITEM BEARING THE STAMP OF A LICENSED PROFESSIONAL IS ALTERED, THE ALTERING ENGINEER, ARCHITECT, LANDSCAPE ARCHITECT, OR LAND SURVEYOR SHALL STAMP THE DOCUMENT AND INCLUDE THE NOTATION "ALTERED BY" FOLLOWED BY THEIR SIGNATURE, THE DATE OF SUCH ALTERATION, AND A SPECIFIC DESCRIPTION OF THE ALTERATION.

PROJECT MANAGER: S. KERN
 CHECK: S. KERN
 DRAFTING: F. CUOCCIO
 CHECK: B. WEAVER
 DESIGN: S. KERN
 JOB MANAGER: D. THOMAS
 DESIGN SUPERVISOR: J. SIMKULET

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 DATE/TIME = 4/15/2021
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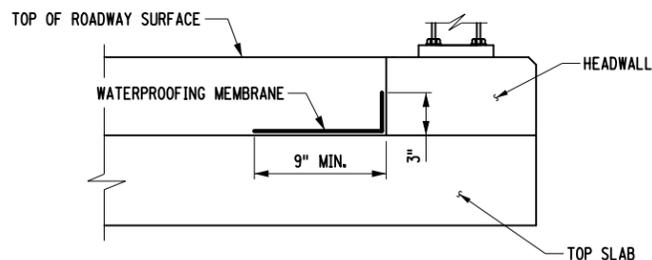


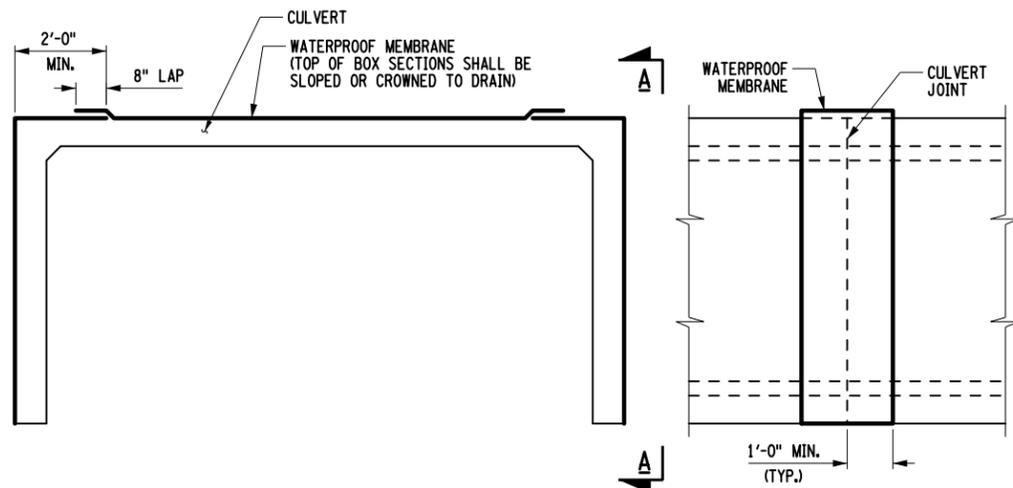NOTE:
 WHEN SPLICES ARE REQUIRED IN THE
 WATERPROOF MEMBRANE, LOCATE AS SHOWN.

CULVERT SECTION

SECTION A-A


**WATERPROOF MEMBRANE
 SPLICE DETAIL**
 NOT TO SCALE



WATERPROOFING MEMBRANE AT HEADWALL
 NOT TO SCALE


NOTES:

1. ADDITIONAL SHIMS ARE ALLOWED AT THE CONTRACTORS OPTION.
2. GROUT SHALL MEET THE REQUIREMENTS OF §701-05 OR §701-06.

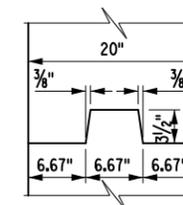

KEYWAY BETWEEN WINGWALL AND FOOTING
 NOT TO SCALE

SPAN UNIT LEG WIDTH ASSUMED TO BE 12 in.
 IF THE ACTUAL LEG WIDTH IS WIDER THAN THE
 ASSUMED WIDTH, THE FOOTING MUST BE WIDENED
 BY AN EQUAL AMOUNT TO KEEP THE VERTICAL
 LOAD IN THE CENTER OF THE FOOTING.

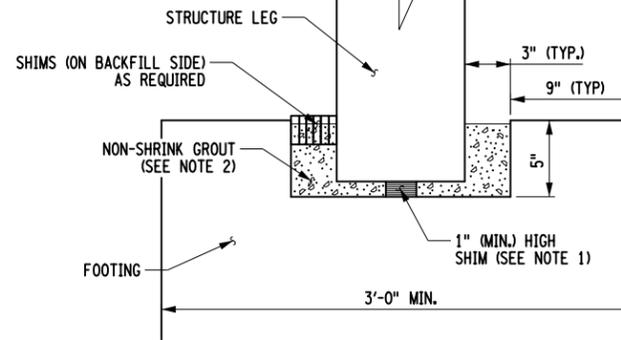

DETAIL A
 NOT TO SCALE


AFFIX SEAL: GREENMAN - PEDERSEN, INC ON: APRIL 15, 2021		ALTERED BY: ON:	
		AS-BUILT REVISIONS	
		DESCRIPTION OF ALTERATIONS:	
		VETERAN'S ROAD CULVERT REPLACEMENT	
		OVER FIVE MILE CREEK	
		TOWN OF TICONDEROGA	PIN 1761.09
		COUNTY: ESSEX	REGION: 1

BRIDGES		CULVERTS		ALL DIMENSIONS IN ft UNLESS OTHERWISE NOTED		CONTRACT NUMBER D036296	
MISCELLANEOUS DETAILS				DRAWING NO. ST-23 SHEET NO. 35			
				GPI GREENMAN-PEDERSEN, INC. CONSULTING ENGINEERS		TOWN OF TICONDEROGA	

IT IS A VIOLATION OF LAW FOR ANY PERSON, UNLESS THEY ARE ACTING UNDER THE DIRECTION OF A LICENSED PROFESSIONAL ENGINEER, ARCHITECT, LANDSCAPE ARCHITECT, OR LAND SURVEYOR, TO ALTER AN ITEM IN ANY WAY. IF AN ITEM BEARING THE STAMP OF A LICENSED PROFESSIONAL IS ALTERED, THE ALTERING ENGINEER, ARCHITECT, LANDSCAPE ARCHITECT, OR LAND SURVEYOR SHALL STAMP THE DOCUMENT AND INCLUDE THE NOTATION "ALTERED BY" FOLLOWED BY THEIR SIGNATURE, THE DATE OF SUCH ALTERATION, AND A SPECIFIC DESCRIPTION OF THE ALTERATION.


PROJECT MANAGER S. KERN
 CHECK S. KERN
 DRAFTING F. CUOCCIO
 CHECK B. WEAVER
 DESIGN S. KERN
 JOB MANAGER D. THOMAS
 DESIGN SUPERVISOR J. SIMKULET

FILE NAME = ...CADD\176109_CPB_WTR_PLN.dgn
 DATE/TIME = 4/15/2021
 USER = skern

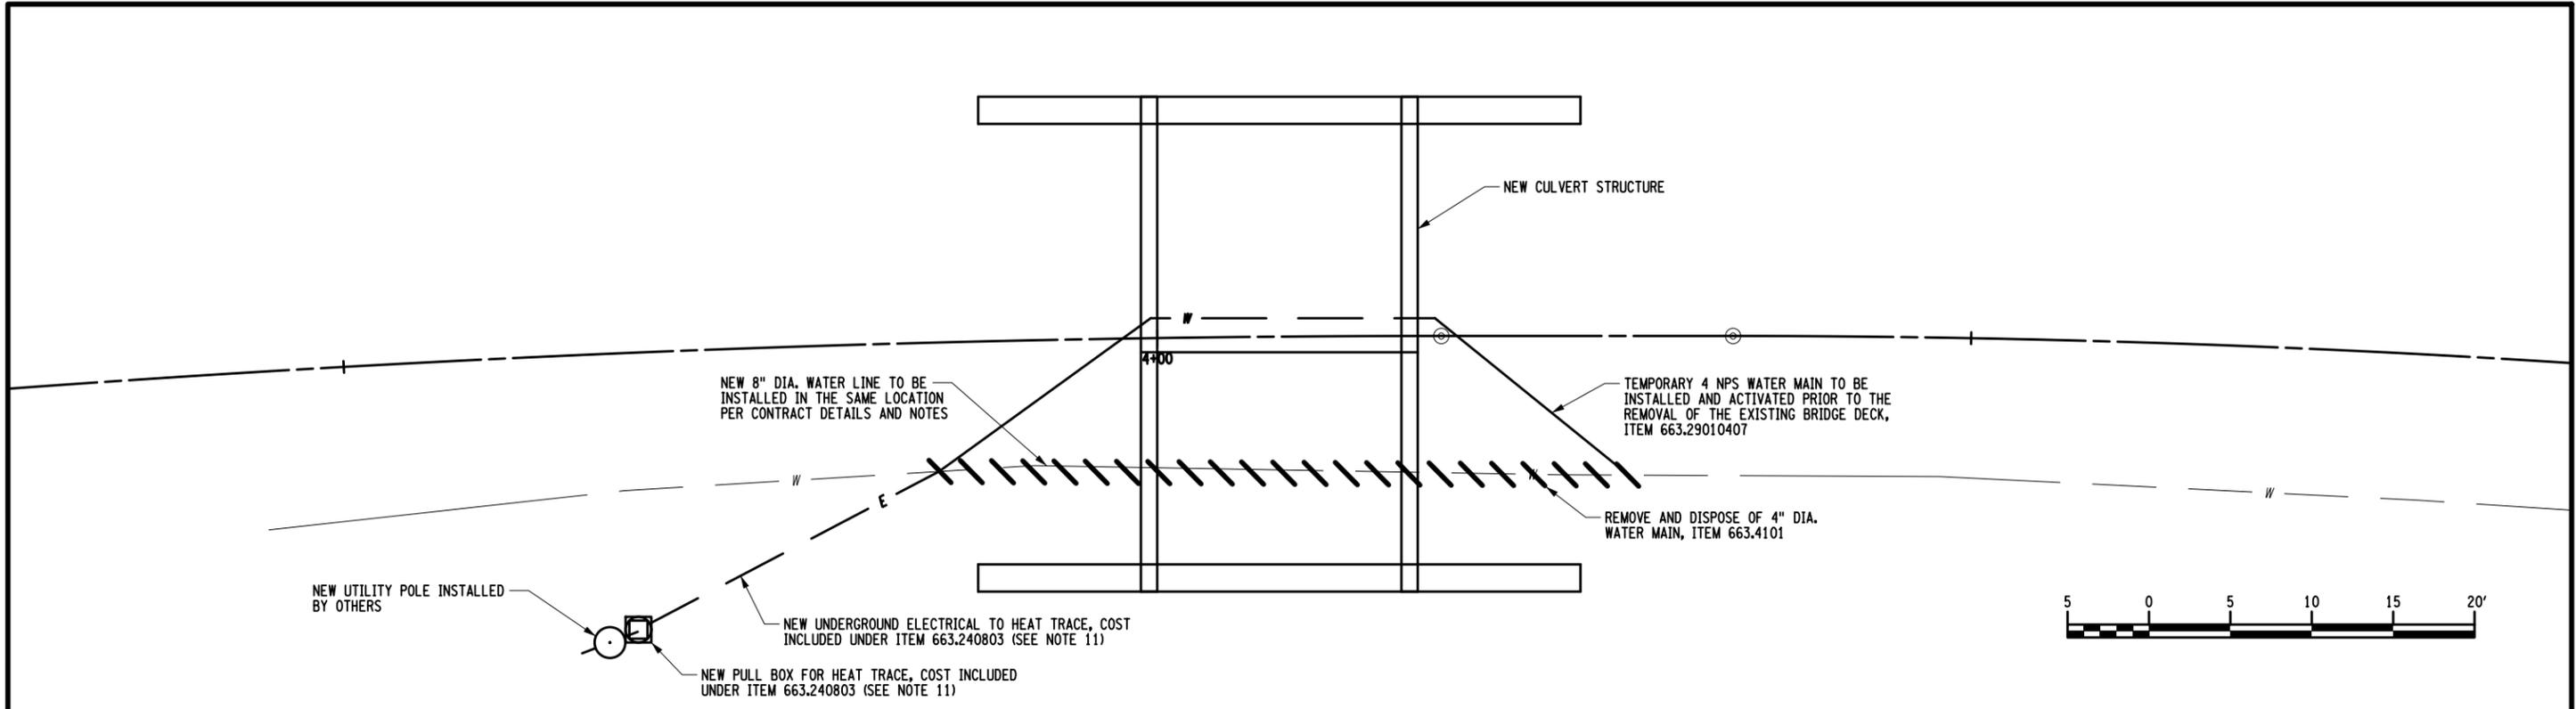


NOTES:

1. THE EXISTING WATER MAIN CONSISTS OF A 4" DIA. PIPE. ALL MATERIALS AND PROCEDURES EMPLOYED BY THE CONTRACTOR TO TAP, REMOVE AND/OR DISPOSE OF SECTIONS OF THIS PIPE SHALL COMPLY WITH CURRENT NYS DOT STANDARD SPECIFICATIONS AND ALL APPLICABLE ENVIRONMENTAL STANDARDS AND REGULATIONS.
2. ALL PORTIONS OF THE EXISTING WATER DISTRIBUTION SYSTEM THAT ARE NOT IMPACTED BY THIS PROJECT SHALL REMAIN IN SERVICE AT ALL TIMES.
3. THE CONTRACTOR SHALL LOCATE ALL EXISTING WATER MAINS WITHIN THE PROJECT LIMITS IN ORDER TO VERIFY THEIR LOCATIONS, SIZES, GRADES AND CONFIGURATIONS. THE COST FOR THIS WORK SHALL BE INCLUDED IN THE VARIOUS WATER ITEMS.
4. THE PROPOSED WATER MAIN SHALL BE PRESSURE TESTED AND DISINFECTED PRIOR TO THEIR CONNECTION TO THE EXISTING WATER DISTRIBUTION SYSTEM. HYDROSTATIC PRESSURE AND LEAKAGE TESTING SHALL BE PERFORMED IN ACCORDANCE WITH THE AMERICAN WATER WORKS ASSOCIATION (AWWA). DISINFECTION AND TESTING SHALL BE PERFORMED IN ACCORDANCE WITH AWWA C651 (STANDARD FOR DISINFECTING WATER MAINS).
5. AFTER THE WATER MAIN HAS BEEN INSTALLED, TESTED AND DISINFECTED TO THE SATISFACTION OF THE ENGINEER AND THE TOWN OF TICONDEROGA, THE CONTRACTOR MAY CONNECT TO THE EXISTING WATER DISTRIBUTION SYSTEM PER THE FOLLOWING CRITERIA:
 - A. ALL CONNECTIONS TO THE EXISTING WATER DISTRIBUTION SYSTEM THAT REQUIRE A SHUT-DOWN OF SERVICE SHALL BE SCHEDULED WITH THE TOWN AT LEAST 1 WEEK IN ADVANCE. NO INTERRUPTION OF WATER SERVICE SHALL EXTEND BEYOND THE SCHEDULED ALLOTTED TIME FRAME.
 - B. THE CONTRACTOR SHALL HAVE A CONTINGENCY PLAN IN PLACE, PRIOR TO THE INITIAL CONNECTIONS TO THE EXISTING WATER DISTRIBUTION SYSTEM, IN THE EVENT THAT A SHUT-DOWN OF WATER SERVICE EXTENDS BEYOND THE ALLOTTED TIME FRAME. THIS CONTINGENCY PLAN SHALL BE SUBMITTED IN WRITING TO THE ENGINEER AND CLEARLY INDICATE THE MEANS, METHODS AND SEQUENCE OF OPERATIONS THAT WOULD BE NECESSARY IN THIS EVENT. THE ENGINEER AND THE TOWN OF TICONDEROGA SHALL APPROVE THIS PLAN PRIOR TO THE START OF CONNECTION OPERATIONS. THE COST OF THE CONTINGENCY PLAN AND ITS IMPLEMENTATION, IF NECESSARY, SHALL BE INCLUDED UNDER THE VARIOUS PROPOSED WATER MAIN ITEMS.
6. THE COST FOR REMOVAL AND DISPOSAL OF THE EXISTING WATER MAIN, INSULATION AND ANY APPURTANCES, LOCATED WITHIN THE PROJECT LIMITS, SHALL BE INCLUDED UNDER ITEM 663.4104. THESE COSTS SHALL INCLUDE, BUT ARE NOT LIMITED TO, ALL LABOR, MATERIALS, EQUIPMENT, AND INSURANCES DEEMED NECESSARY TO SATISFACTORILY COMPLETE THE WORK.
7. REFER TO NYS DOT STANDARD SHEETS 663-01 THROUGH 663-07 FOR ADDITIONAL NOTES AND DETAILS.
8. THE LOCATIONS AND ELEVATIONS OF THE EXISTING WATER MAIN SHOWN IS APPROXIMATE AND SHALL BE FIELD VERIFIED BY THE CONTRACTOR PRIOR TO INSTALLATION OF THE PROPOSED WATER MAIN.
9. DUE TO UNEXPECTED FIELD CONDITIONS, THE CONTRACTOR MAY PROPOSE ALTERNATE ROUTE(S) FOR THE NEW WATER MAIN. ANY PROPOSAL FOR CHANGES MUST BE MADE IN WRITING AND APPROVED BY THE E.I.C. PRIOR TO CONSTRUCTION.
10. THE PROPOSED UNDERGROUND WATER MAIN SHALL BE INSULATED AT ALL LOCATIONS WHERE COVER IS LESS THAN 5'-0", AS MEASURED FROM THE TOP OF THE PIPE AND A.O.B.E. (ITEM 663.240803).
11. A HEAT TRACE SYSTEM SHALL BE INSTALLED WITH THE NEW WATER LINE WITHIN THE LIMITS SHOWN ON THESE PLANS. THE CONTRACTOR SHALL PROVIDE THE ENGINEER THE HEAT TRACE SUPPLIER AND SPECIFICATIONS FOR APPROVAL PRIOR TO PURCHASING. ALL COST ASSOCIATED WITH THE HEAT TRACE, ELECTRICAL LINE, AND PULL BOXES SHALL BE INCLUDED IN THE UNIT PRICE BID FOR THE PIPE INSULATION, ITEM 663.240803.

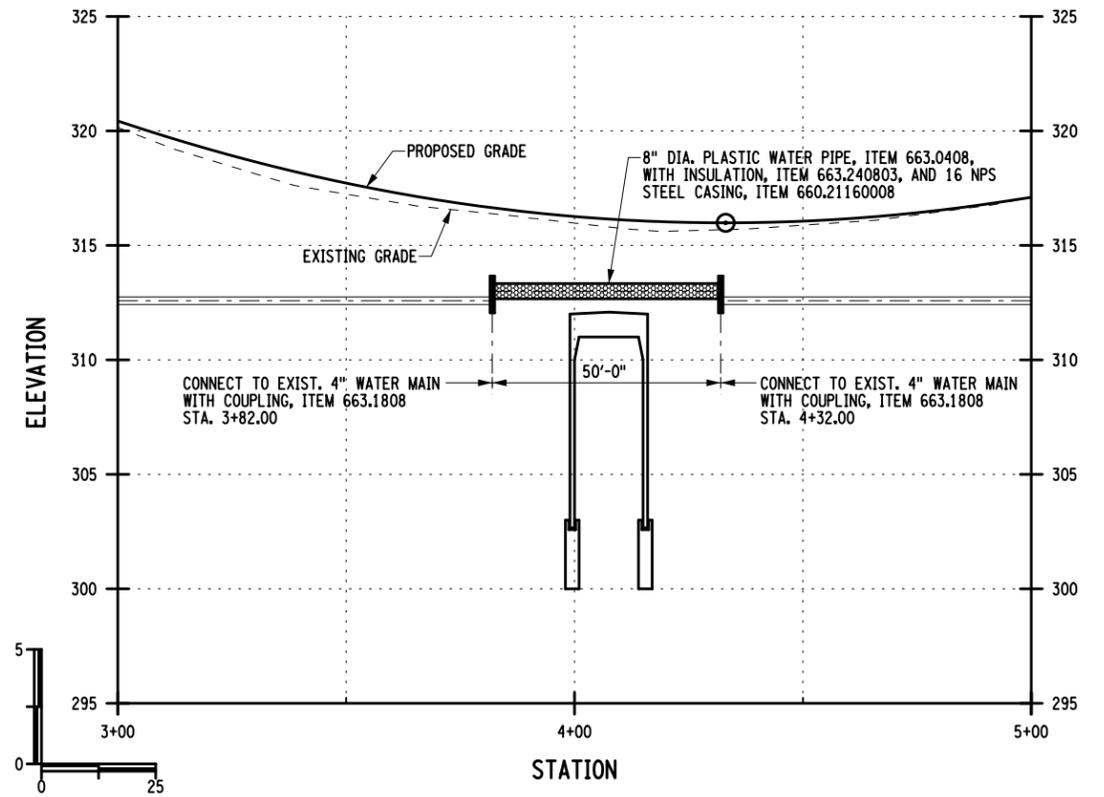

PROPOSED WATER MAIN PROFILE

AFFIX SEAL: GREENMAN - PEDERSEN, INC
 ON: APRIL 15, 2021
 ALTERED BY:
 ON:

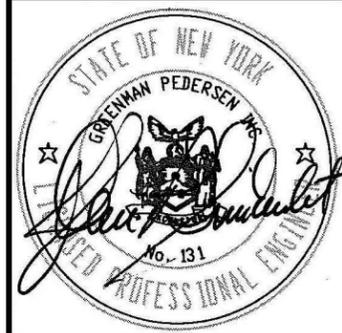


AS-BUILT REVISIONS DESCRIPTION OF ALTERATIONS:	VETERAN'S ROAD CULVERT REPLACEMENT	PIN 1761.09	BRIDGES	CULVERTS	ALL DIMENSIONS IN FT UNLESS OTHERWISE NOTED	CONTRACT NUMBER D036296
	OVER FIVE MILE CREEK					DRAWING NO. ST-24 SHEET NO. 36
	TOWN OF TICONDEROGA				WATER MAIN PLAN AND PROFILE	GPI GREENMAN-PEDERSEN, INC. CONSULTING ENGINEERS
	COUNTY: ESSEX	REGION: 1				


IT IS A VIOLATION OF LAW FOR ANY PERSON, UNLESS THEY ARE ACTING UNDER THE DIRECTION OF A LICENSED PROFESSIONAL ENGINEER, ARCHITECT, LANDSCAPE ARCHITECT, OR LAND SURVEYOR, TO ALTER AN ITEM IN ANY WAY. IF AN ITEM BEARING THE STAMP OF A LICENSED PROFESSIONAL IS ALTERED, THE ALTERING ENGINEER, ARCHITECT, LANDSCAPE ARCHITECT, OR LAND SURVEYOR SHALL STAMP THE DOCUMENT AND INCLUDE THE NOTATION "ALTERED BY" FOLLOWED BY THEIR SIGNATURE, THE DATE OF SUCH ALTERATION, AND A SPECIFIC DESCRIPTION OF THE ALTERATION.

FILE NAME = ... \CADD\176109_CPB_WTR_DTL.dgn
 DATE/TIME = 4/15/2021
 USER = skern

DESIGN SUPERVISOR J. SIMKULET
 JOB MANAGER D. THOMAS
 DESIGN S. KERN
 CHECK B. WEAVER
 DRAFTING F. CIUCCIO
 CHECK S. KERN
 PROJECT MANAGER S. KERN

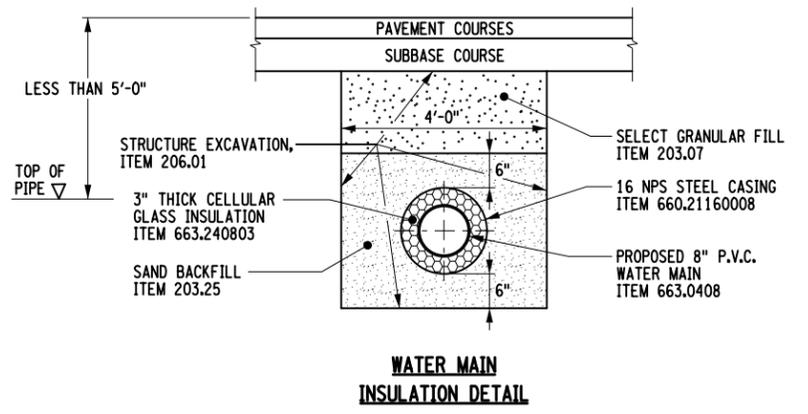

- WATER MAIN INSULATION NOTES:**
1. THE PROPOSED WATER MAIN SHALL BE INSULATED AT ALL LOCATIONS WHERE COVER IS LESS THAN 5'-0", AS MEASURED FROM THE TOP OF THE PIPE, AND A.O.B.E.
 2. INSULATION SHALL BE INSTALLED IN ACCORDANCE WITH THE MANUFACTURER'S RECOMMENDATIONS.
 3. ALL COSTS FOR THE INSULATION OF THE PROPOSED WATER MAIN SHALL BE COVERED UNDER ITEM 663.240803. THIS INCLUDES, BUT IS NOT LIMITED TO, LABOR, EQUIPMENT, INSULATION, COVERING, TAPE, ETC., EXCEPT EXCAVATION AND BACKFILL SHALL BE PAID FOR UNDER THEIR RESPECTIVE ITEMS.

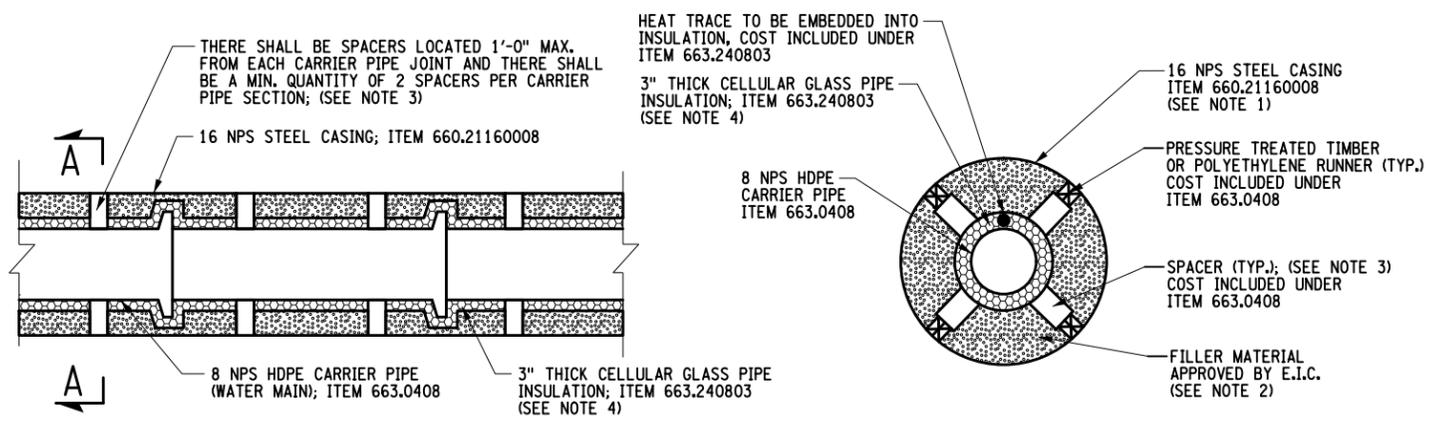

LONGITUDINAL SECTION
SECTION A-A
WATER MAIN CASING DETAIL

- STEEL CASING NOTES:**
1. CASING SHALL BE A SCHEDULE 40 STEEL PIPE; CASING PIPE SECTIONS SHALL BE BUTT WELDED TOGETHER; MIN. INSIDE DIAMETER OF CASING PIPE SHALL BE 6" TO 8" GREATER THAN THE OUTSIDE DIAMETER OF THE CARRIER PIPE'S BELLS.
 2. ANNULAR SPACE SHALL BE FILLED WITH GROUT, SAND OR APPROVED MATERIAL A.O.B.E.; COST INCLUDED UNDER ITEM 663.0408.
 3. EACH SECTION OF HDPE CARRIER PIPE WITHIN THE CASING SHALL CONTAIN A MINIMUM OF TWO (2) SPACERS; ALL CARRIER PIPE SECTIONS WITHIN THE CASING SHALL HAVE RESTRAINED JOINTS. COST INCLUDED UNDER ITEM 663.0408.
 4. PIPE INSULATION SHALL BE TRIMMED AND REMOVED AS NECESSARY TO ACCOMMODATE SPACERS. COST INCLUDED UNDER ITEM 663.240803.

AFFIX SEAL: GREENMAN - PEDERSEN, INC
 ON: APRIL 15, 2021


ALTERED BY:
 ON:



AS-BUILT REVISIONS DESCRIPTION OF ALTERATIONS:	VETERAN'S ROAD CULVERT REPLACEMENT OVER FIVE MILE CREEK	PIN 1761.09	BRIDGES	CULVERTS	ALL DIMENSIONS IN ft UNLESS OTHERWISE NOTED	CONTRACT NUMBER D036296
	TOWN OF TICONDEROGA				WATER MAIN DETAILS	DRAWING NO. ST-25 SHEET NO. 37
	COUNTY: ESSEX REGION: 1					
IT IS A VIOLATION OF LAW FOR ANY PERSON, UNLESS THEY ARE ACTING UNDER THE DIRECTION OF A LICENSED PROFESSIONAL ENGINEER, ARCHITECT, LANDSCAPE ARCHITECT, OR LAND SURVEYOR, TO ALTER AN ITEM IN ANY WAY. IF AN ITEM BEARING THE STAMP OF A LICENSED PROFESSIONAL IS ALTERED, THE ALTERING ENGINEER, ARCHITECT, LANDSCAPE ARCHITECT, OR LAND SURVEYOR SHALL STAMP THE DOCUMENT AND INCLUDE THE NOTATION "ALTERED BY" FOLLOWED BY THEIR SIGNATURE, THE DATE OF SUCH ALTERATION, AND A SPECIFIC DESCRIPTION OF THE ALTERATION.					GPI GREENMAN-PEDERSEN, INC. CONSULTING ENGINEERS	TOWN OF TICONDEROGA

PROJECT MANAGER S. KERN
 CHECK S. KERN
 DRAFTING F. CIUCCIO
 CHECK B. WEAVER
 DESIGN S. KERN
 JOB MANAGER D. THOMAS
 DESIGN SUPERVISOR J. SIMKULET

FILE NAME = ...CADD\176109_CPB_RLG_PLN.P.dgn
 DATE/TIME = 4/15/2021
 USER = skern

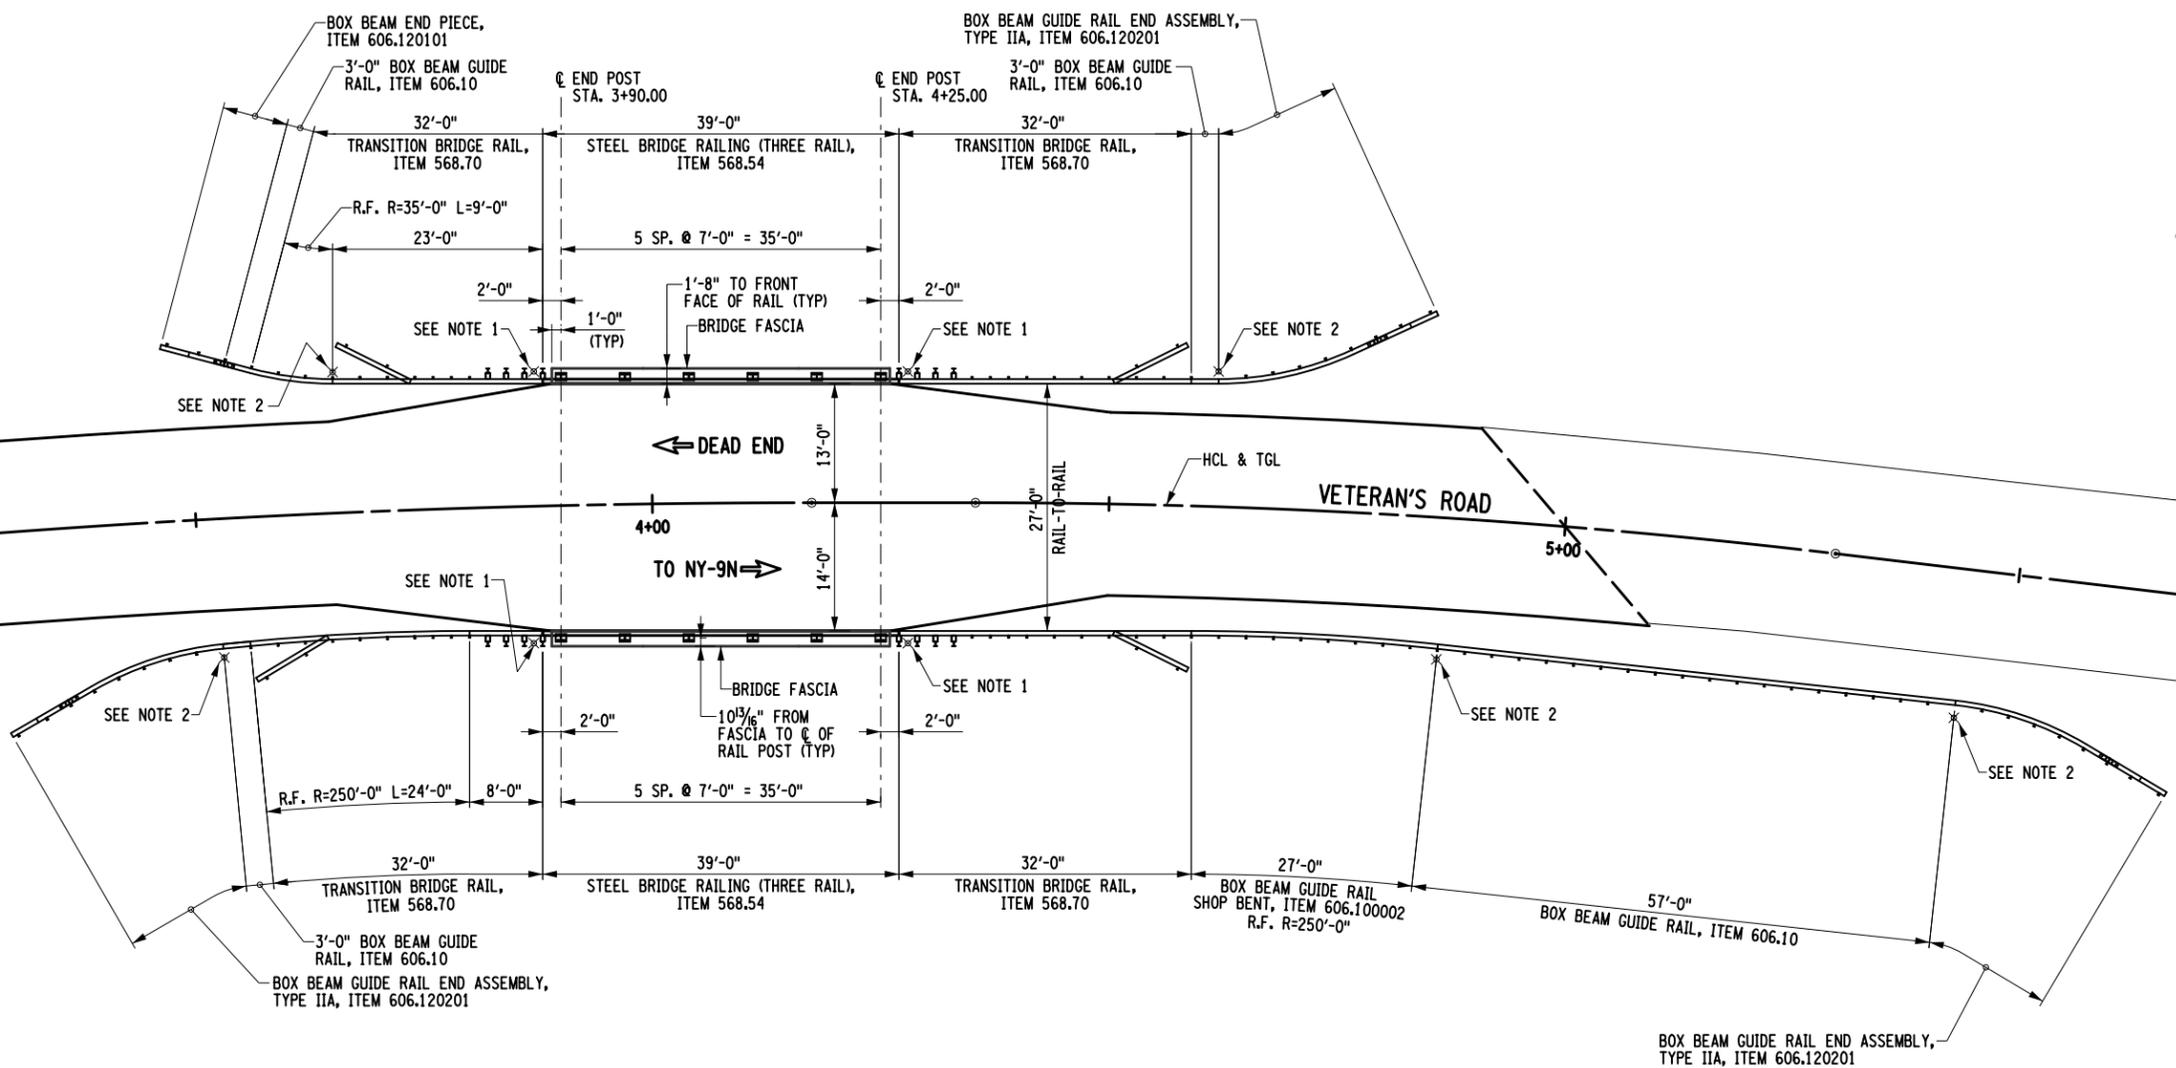

PROPOSED RAILING PLAN
 SCALE: 1"=20'

NOTES:

1. COMMON 2.0 LB/FT STEEL POST, ITEM 646.32, WITH ONE LARGE SUPPLEMENTARY SNOWPLOWING MARKER SINGLE UNIT PANEL ON BOTH SIDES OF POST (PAID AS TWO PANELS FOR EACH POST LOCATION, ITEM 646.23). TYPICAL FOR BEHIND ALL FOUR TRANSITION RAILINGS BETWEEN FIRST AND SECOND POST AND WHERE SHOWN ON PLANS.
2. COMMON 2.0 LB/FT STEEL POST, ITEM 646.32, WITH ONE LARGE SNOWPLOWING MARKER SINGLE UNIT PANEL ON THE POST SIDE FACING ONCOMING TRAFFIC, ITEM 646.23. TYPICAL AT POINT OF TANGENCY AS SHOWN ON PLANS.








AFFIX SEAL: GREENMAN - PEDERSEN, INC
 ON: APRIL 15, 2021

ALTERED BY:
 ON:

AS-BUILT REVISIONS DESCRIPTION OF ALTERATIONS:	VETERAN'S ROAD CULVERT REPLACEMENT	PIN 1761.09	BRIDGES	CULVERTS	ALL DIMENSIONS IN FT UNLESS OTHERWISE NOTED	CONTRACT NUMBER D036296
	OVER FIVE MILE CREEK					DRAWING NO. ST-26 SHEET NO. 38
		TOWN OF TICONDEROGA	PROPOSED RAILING PLAN			TOWN OF TICONDEROGA
		COUNTY: ESSEX REGION: 1				
IT IS A VIOLATION OF LAW FOR ANY PERSON, UNLESS THEY ARE ACTING UNDER THE DIRECTION OF A LICENSED PROFESSIONAL ENGINEER, ARCHITECT, LANDSCAPE ARCHITECT, OR LAND SURVEYOR, TO ALTER AN ITEM IN ANY WAY. IF AN ITEM BEARING THE STAMP OF A LICENSED PROFESSIONAL IS ALTERED, THE ALTERING ENGINEER, ARCHITECT, LANDSCAPE ARCHITECT, OR LAND SURVEYOR SHALL STAMP THE DOCUMENT AND INCLUDE THE NOTATION "ALTERED BY" FOLLOWED BY THEIR SIGNATURE, THE DATE OF SUCH ALTERATION, AND A SPECIFIC DESCRIPTION OF THE ALTERATION.						

FILE NAME = ... \CADD\176109_CPB_RLG.DTL-1.dgn
 DATE/TIME = 4/15/2021
 USER = skeern

PROJECT MANAGER: S. KERN
 CHECK: S. KERN
 DRAFTING: F. CUOCCIO
 CHECK: B. WEAVER
 DESIGN: S. KERN
 JOB MANAGER: D. THOMAS
 DESIGN SUPERVISOR: J. SIMKULET

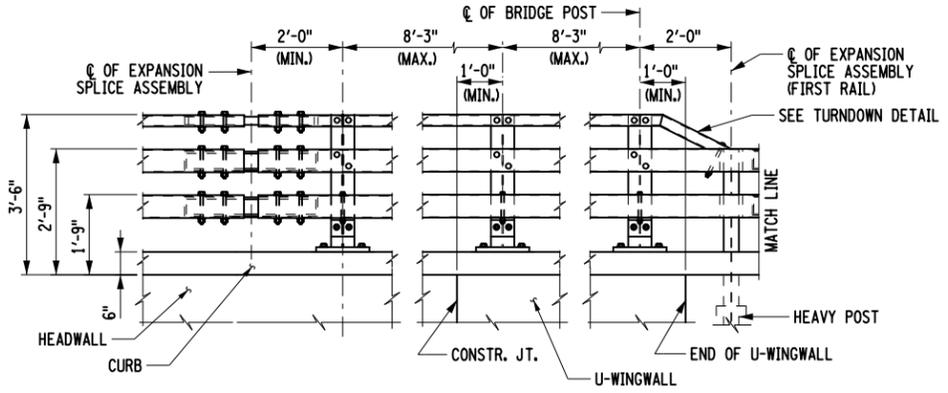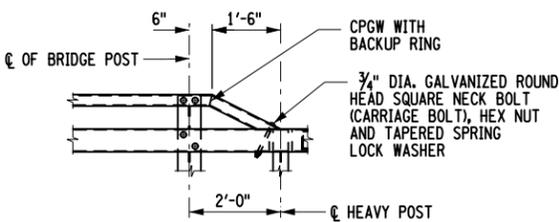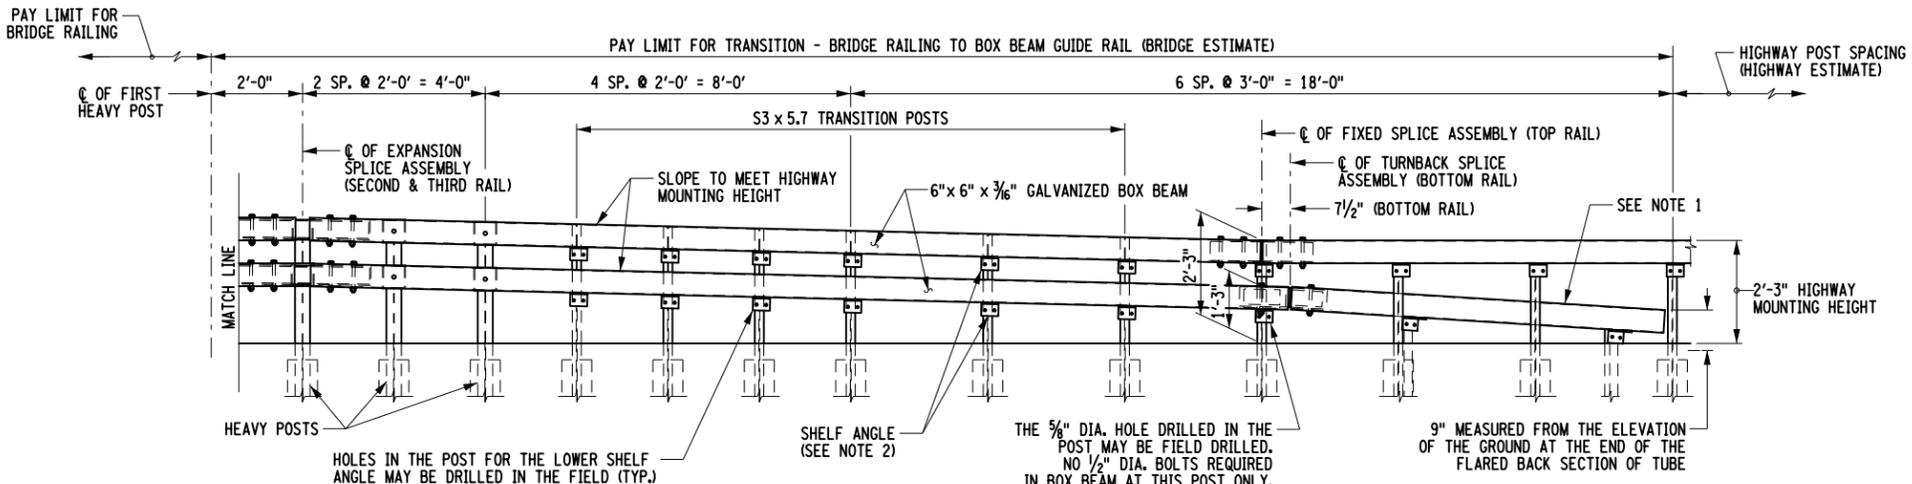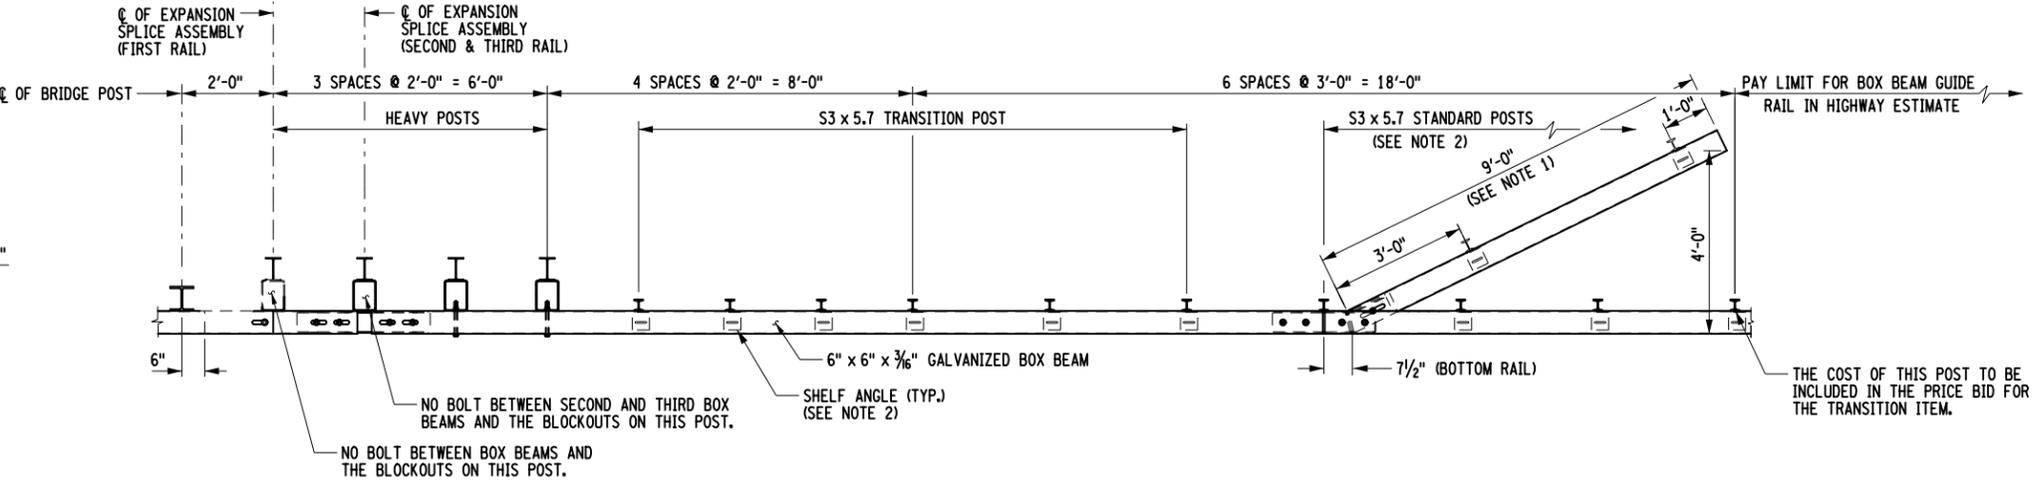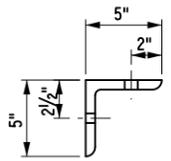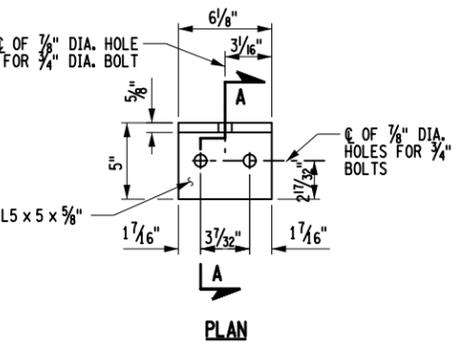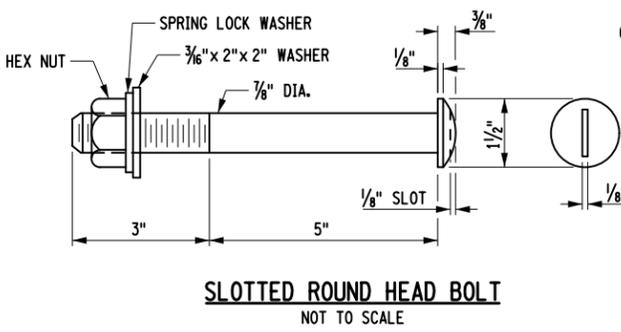

- NOTES:**
1. THE COST OF THE POSTS, SPLICE TUBE AND RAIL FOR THE LOWER TUBE FLARE SECTION IS INCLUDED IN THE PRICE BID FOR THE TRANSITION ITEM.
 2. SEE TYPICAL RAIL TO POST CONNECTION DETAIL ON CURRENT HIGHWAY STANDARD SHEET TITLED "BOX BEAM GUIDE RAIL".

AFFIX SEAL: GREENMAN - PEDERSEN, INC
 ON: APRIL 15, 2021
 ALTERED BY:
 ON:




AS-BUILT REVISIONS DESCRIPTION OF ALTERATIONS:	VETERAN'S ROAD CULVERT REPLACEMENT	PIN 1761.09	BRIDGES	CULVERTS	ALL DIMENSIONS IN FT UNLESS OTHERWISE NOTED	CONTRACT NUMBER D036296
	OVER FIVE MILE CREEK					RAILING DETAILS (1 OF 3)
	TOWN OF TICONDEROGA					
	COUNTY: ESSEX	REGION: 1				


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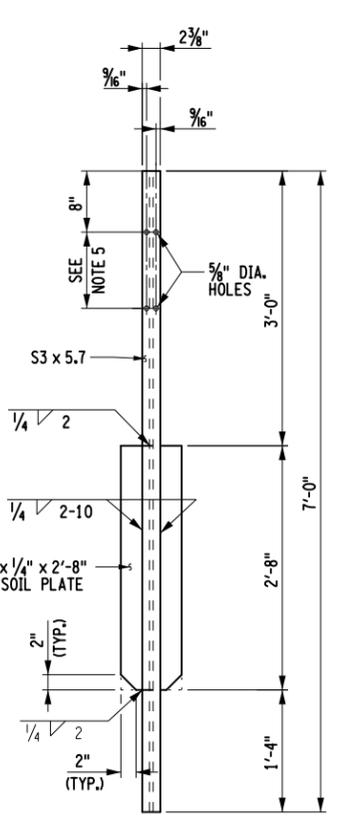
PROJECT MANAGER: S. KERN
 CHECK: S. KERN
 DRAFTING: F. CUOCCIO
 CHECK: B. WEAVER
 DESIGN: S. KERN
 JOB MANAGER: D. THOMAS
 DESIGN SUPERVISOR: J. SIMKULET




HEAVY POST DETAIL
NOT TO SCALE

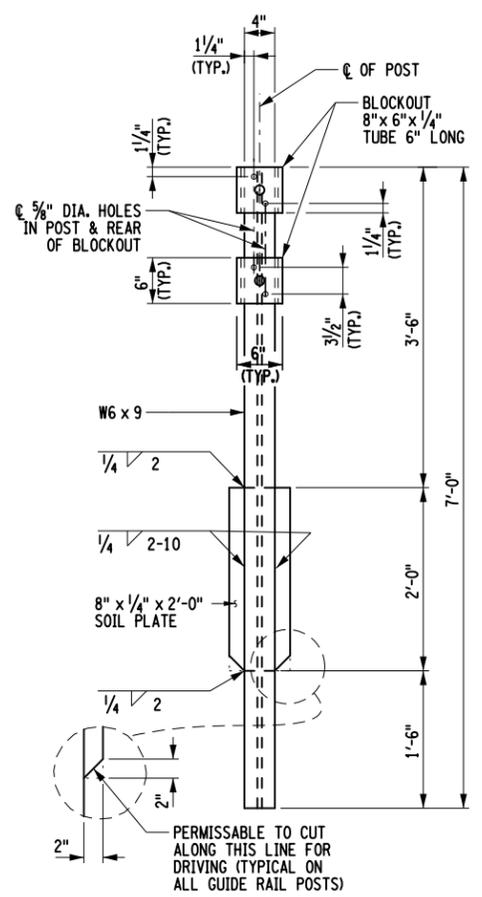


HEAVY POST ELEVATION
NOT TO SCALE

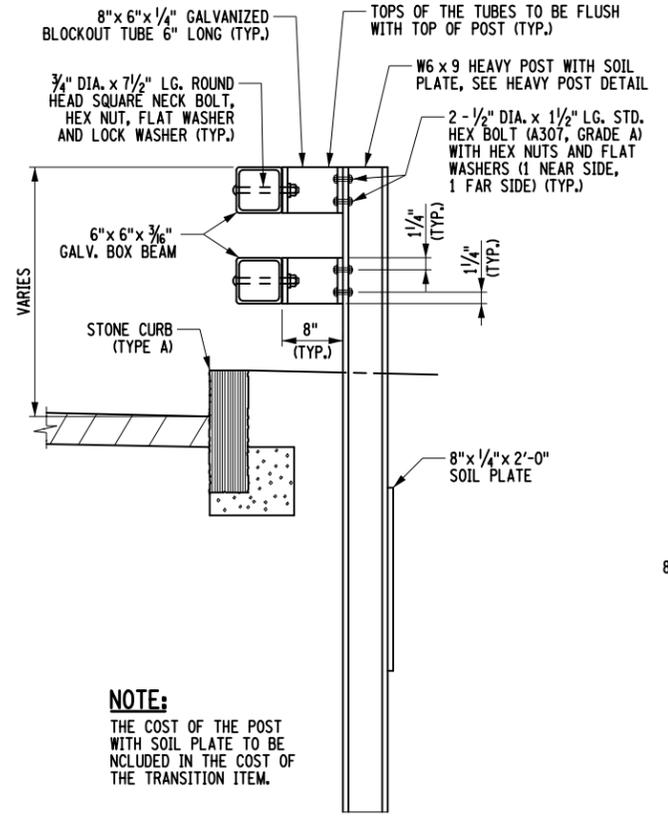

TRANSITION POST DETAIL
NOT TO SCALE

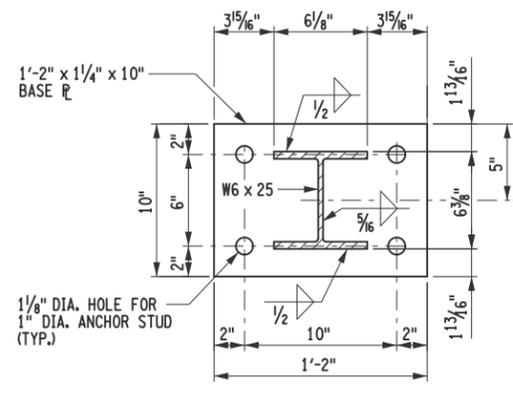


SECTION A-A
NOT TO SCALE

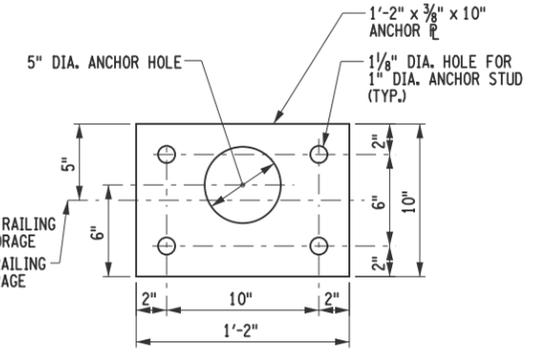


SECTION B-B
NOT TO SCALE


- NOTES:**
1. ALL RAILING IS TO BE FABRICATED AND ERECTED ACCORDING TO SECTION 568 OF THE STANDARD SPECIFICATIONS.
 2. PRIOR TO GALVANIZING THE ASSEMBLED POST, GRIND ALL EDGES TO A MINIMUM RADIUS OF 1/16".
 3. BOLTS SHALL BE TORQUED SNUG TIGHT (APPROXIMATELY 100 FT-LB).
 4. PROTRUSIONS CAUSED BY WELDING OR GALVANIZING ARE NOT PERMITTED ON THE ADJOINING SURFACES OF THE BOX BEAM RAILS, SPLICE TUBES AND FILL PLATES.
 5. HOLES IN THE POST FOR THE LOWER RAIL MAY BE LOCATED AND DRILLED IN THE FIELD. IF SO, THE GALVANIZING SHALL BE REPAIRED IN ACCORDANCE WITH SUBSECTION 719-01.

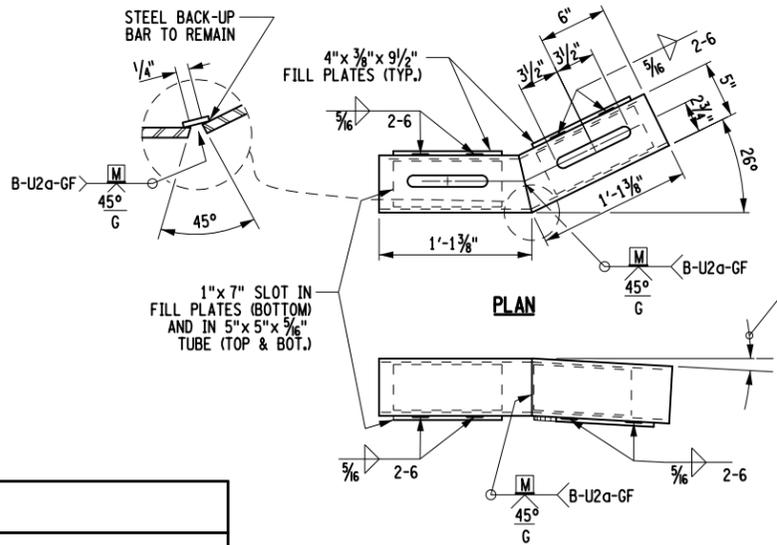

SPLICE TUBE DETAILS FOR TURN BACK
NOT TO SCALE

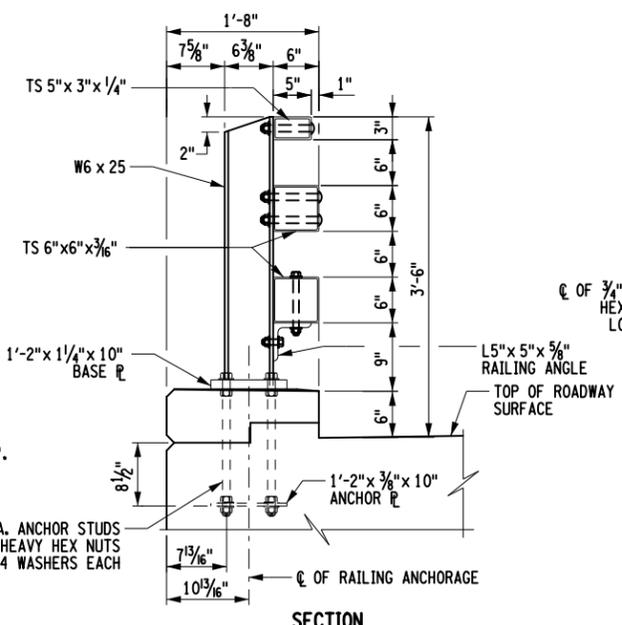

SECTION

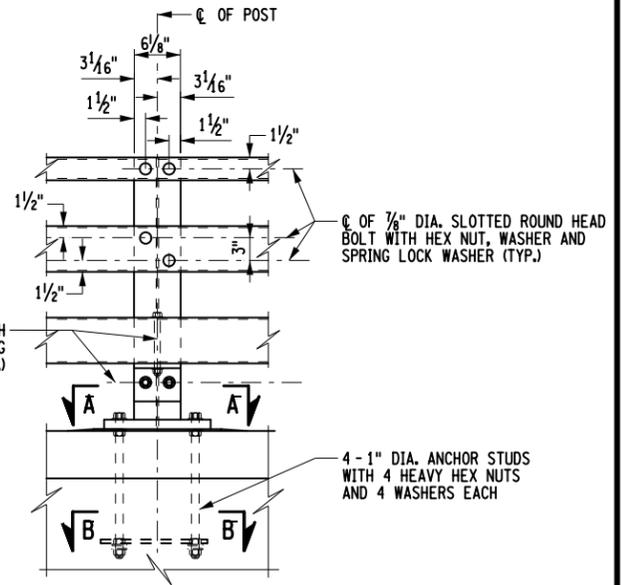

ELEVATION

STEEL BRIDGE RAILING (THREE-RAIL) WITH CURB
NOT TO SCALE

AFFIX SEAL: GREENMAN - PEDERSEN, INC
ON: APRIL 15, 2021



ALTERED BY:
ON:

AS-BUILT REVISIONS DESCRIPTION OF ALTERATIONS:	VETERAN'S ROAD CULVERT REPLACEMENT	PIN 1761.09	BRIDGES	CULVERTS	ALL DIMENSIONS IN FT UNLESS OTHERWISE NOTED	CONTRACT NUMBER D036296
	OVER FIVE MILE CREEK				RAILING DETAILS (2 OF 3)	DRAWING NO. ST-28
	TOWN OF TICONDEROGA					SHEET NO. 40
	COUNTY: ESSEX	REGION: 1				

IT IS A VIOLATION OF LAW FOR ANY PERSON, UNLESS THEY ARE ACTING UNDER THE DIRECTION OF A LICENSED PROFESSIONAL ENGINEER, ARCHITECT, LANDSCAPE ARCHITECT, OR LAND SURVEYOR, TO ALTER AN ITEM IN ANY WAY. IF AN ITEM BEARING THE STAMP OF A LICENSED PROFESSIONAL IS ALTERED, THE ALTERING ENGINEER, ARCHITECT, LANDSCAPE ARCHITECT, OR LAND SURVEYOR SHALL STAMP THE DOCUMENT AND INCLUDE THE NOTATION "ALTERED BY" FOLLOWED BY THEIR SIGNATURE, THE DATE OF SUCH ALTERATION, AND A SPECIFIC DESCRIPTION OF THE ALTERATION.


GPI GREENMAN-PEDERSEN, INC. CONSULTING ENGINEERS

TOWN OF TICONDEROGA


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 DATE/TIME = 4/15/2021
 USER = skern

FILE NAME = ... \CADD\176109_CPB_RL.G.DTL-3.dgn
 DATE/TIME = 4/15/2021
 USER = skeern

PROJECT MANAGER S. KERN
 CHECK S. KERN
 DRAFTING F. CIUCCIO
 CHECK B. WEAVER
 DESIGN S. KERN
 JOB MANAGER D. THOMAS
 DESIGN SUPERVISOR J. SIMKULET

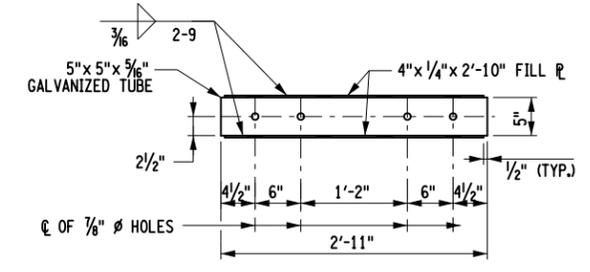


PLAN

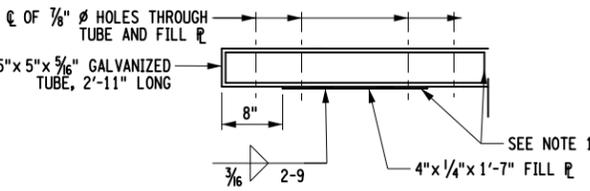


ELEVATION

EXPANSION SPLICE TUBE
 SCALE: NONE

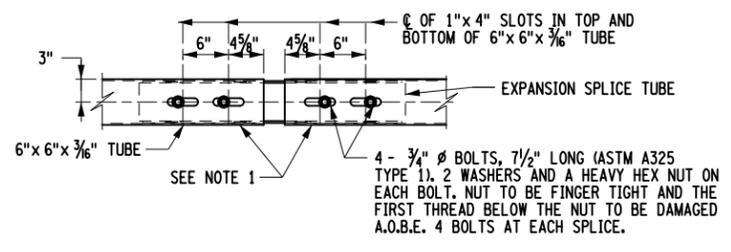


PLAN

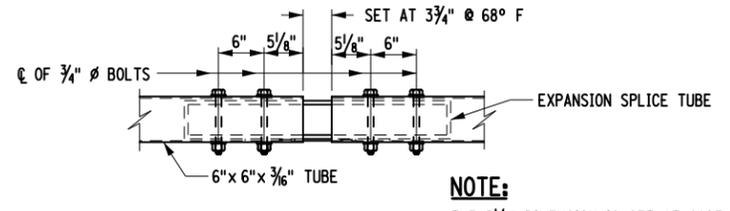


ELEVATION

EXPANSION SPLICE TUBE ASSEMBLY
 SCALE: NONE

NOTE:
 THE 5/8" DIMENSION IS SET AT 68° F.

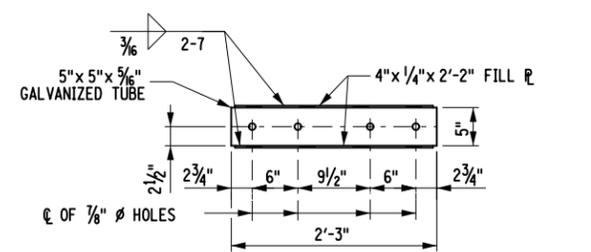


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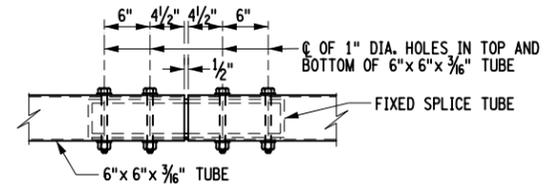


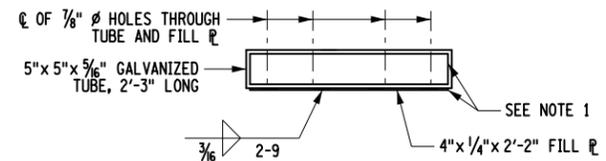ELEVATION

FIXED SPLICE TUBE
 SCALE: NONE

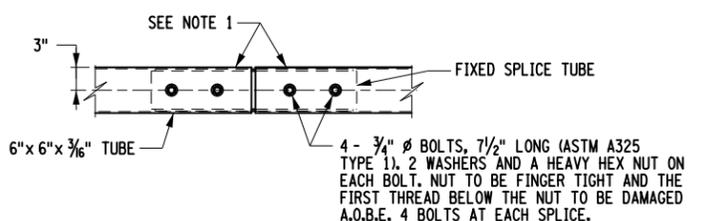


PLAN




ELEVATION

FIXED SPLICE TUBE ASSEMBLY
 SCALE: NONE

NOTE:
 1. PROTRUSIONS CAUSED BY WELDING OR GALVANIZING ARE NOT PERMITTED ON THE ADJOINING SURFACES OF THE BOX BEAM RAILS, SPLICE TUBES AND FILL PLATES.

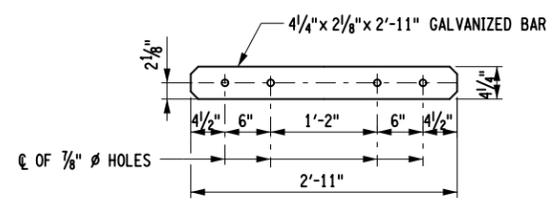


PLAN

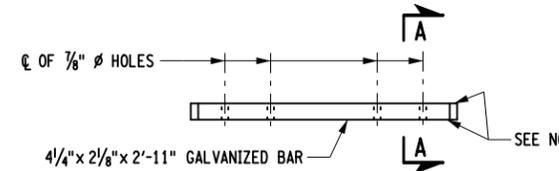


ELEVATION

EXPANSION SPLICE BAR
 SCALE: NONE

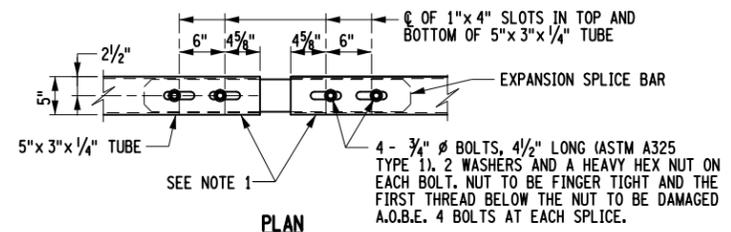


PLAN

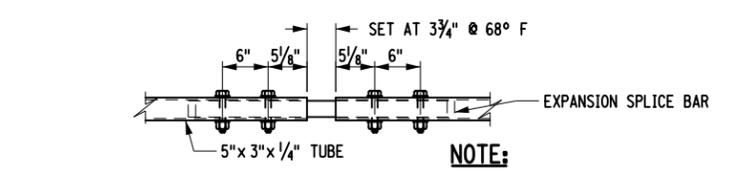


ELEVATION

EXPANSION SPLICE BAR ASSEMBLY
 SCALE: NONE

NOTE:
 THE 5/8" DIMENSION IS SET AT 68° F.

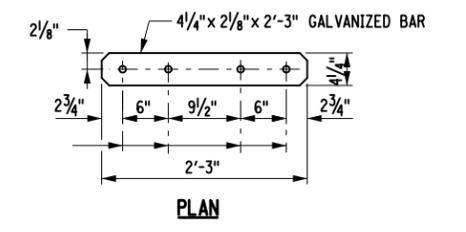


PLAN

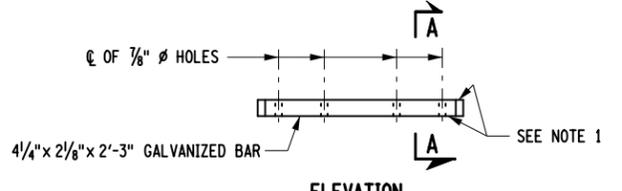


ELEVATION

FIXED SPLICE BAR
 SCALE: NONE

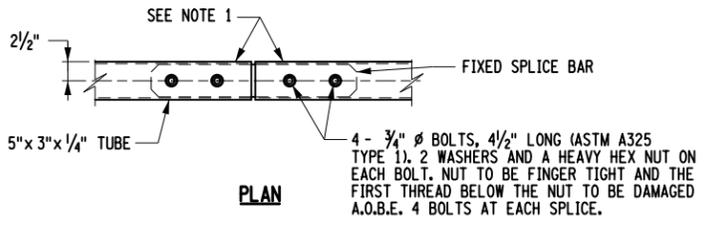


PLAN

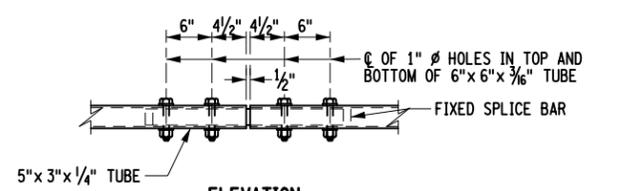

ELEVATION

FIXED SPLICE BAR ASSEMBLY
 SCALE: NONE

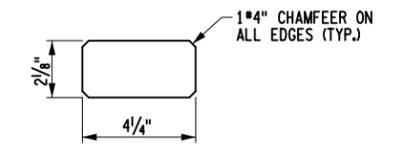

SECTION A-A
 SCALE: NONE

NOTES:
 1. PROTRUSIONS CAUSED BY WELDING OR GALVANIZING ARE NOT PERMITTED ON THE ADJOINING SURFACES OF THE BOX BEAM RAILS, SPLICE TUBES AND FILL PLATES.

AFFIX SEAL: GREENMAN - PEDERSEN, INC
 ON: APRIL 15, 2021
 ALTERED BY:
 ON:



AS-BUILT REVISIONS DESCRIPTION OF ALTERATIONS:	VETERAN'S ROAD CULVERT REPLACEMENT	PIN 1761.09	BRIDGES	CULVERTS	ALL DIMENSIONS IN FT UNLESS OTHERWISE NOTED	CONTRACT NUMBER D036296
	OVER FIVE MILE CREEK				RAILING DETAILS (3 OF 3)	DRAWING NO. ST-29 SHEET NO. 41
	TOWN OF TICONDEROGA					
	COUNTY: ESSEX	REGION: 1				

IT IS A VIOLATION OF LAW FOR ANY PERSON, UNLESS THEY ARE ACTING UNDER THE DIRECTION OF A LICENSED PROFESSIONAL ENGINEER, ARCHITECT, LANDSCAPE ARCHITECT, OR LAND SURVEYOR, TO ALTER AN ITEM IN ANY WAY. IF AN ITEM BEARING THE STAMP OF A LICENSED PROFESSIONAL IS ALTERED, THE ALTERING ENGINEER, ARCHITECT, LANDSCAPE ARCHITECT, OR LAND SURVEYOR SHALL STAMP THE DOCUMENT AND INCLUDE THE NOTATION "ALTERED BY" FOLLOWED BY THEIR SIGNATURE, THE DATE OF SUCH ALTERATION, AND A SPECIFIC DESCRIPTION OF THE ALTERATION.

GPI GREENMAN-PEDERSEN, INC. CONSULTING ENGINEERS
 TOWN OF TICONDEROGA

FILE NAME = ... \CADD\176109_CPB_BAR.dgn
 DATE/TIME = 4/15/2021
 USER = skern

DESIGN SUPERVISOR J. SIMKULET

JOB MANAGER D. THOMAS





DESIGN S. KERN

CHECK B. WEAVER

DRAFTING F. CIUCCIO

CHECK S. KERN

PROJECT MANAGER S. KERN

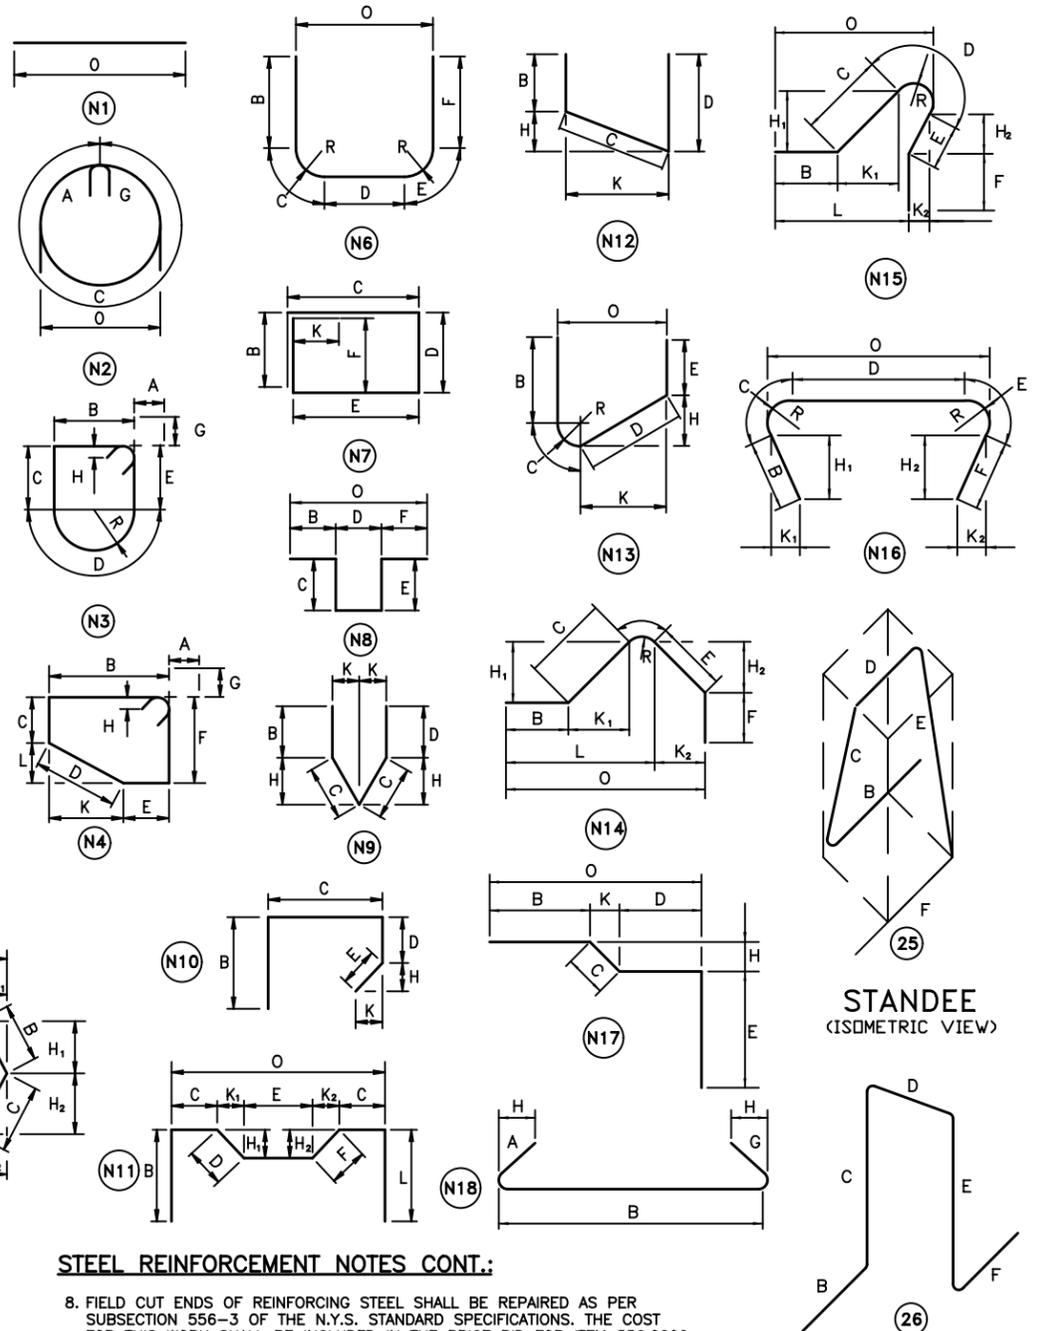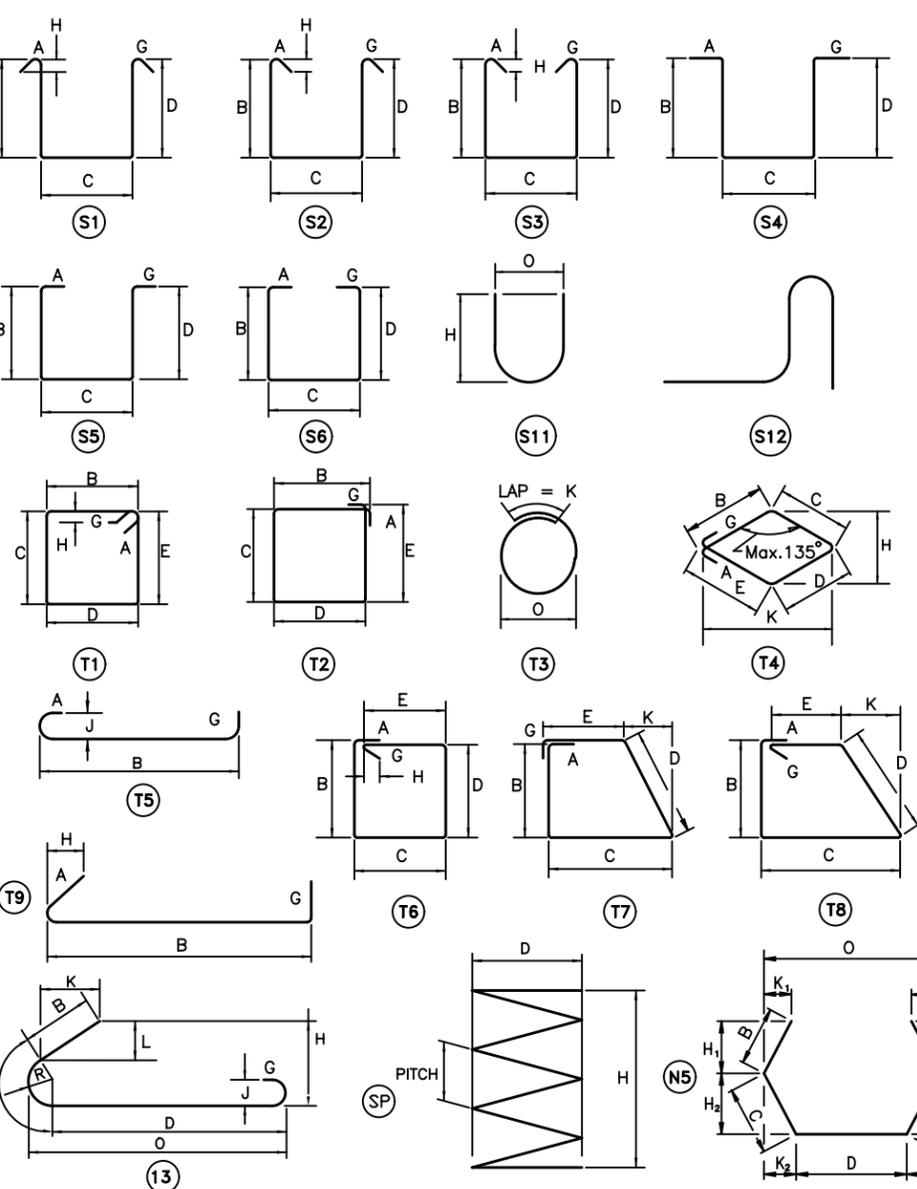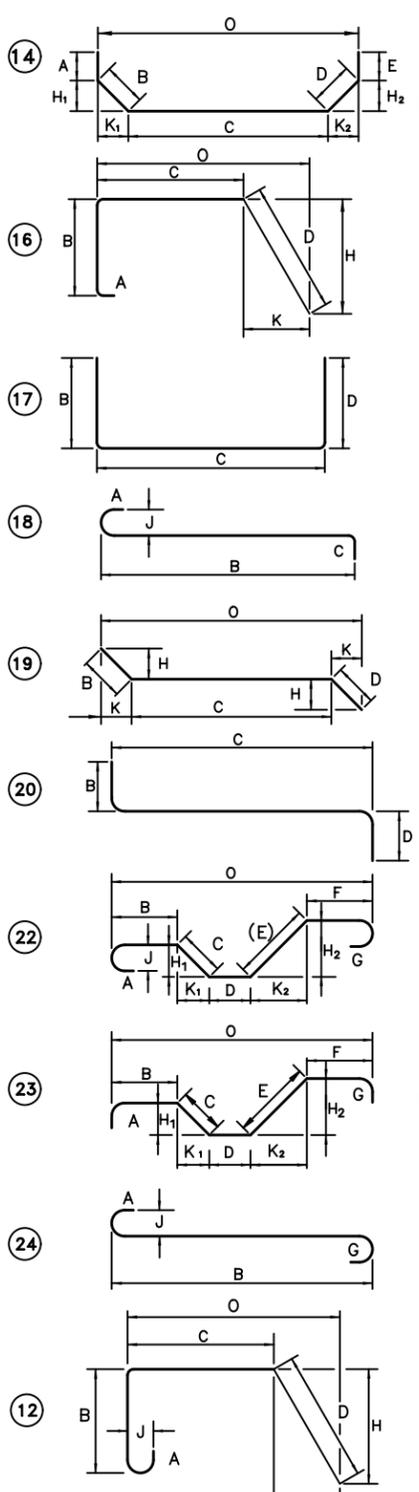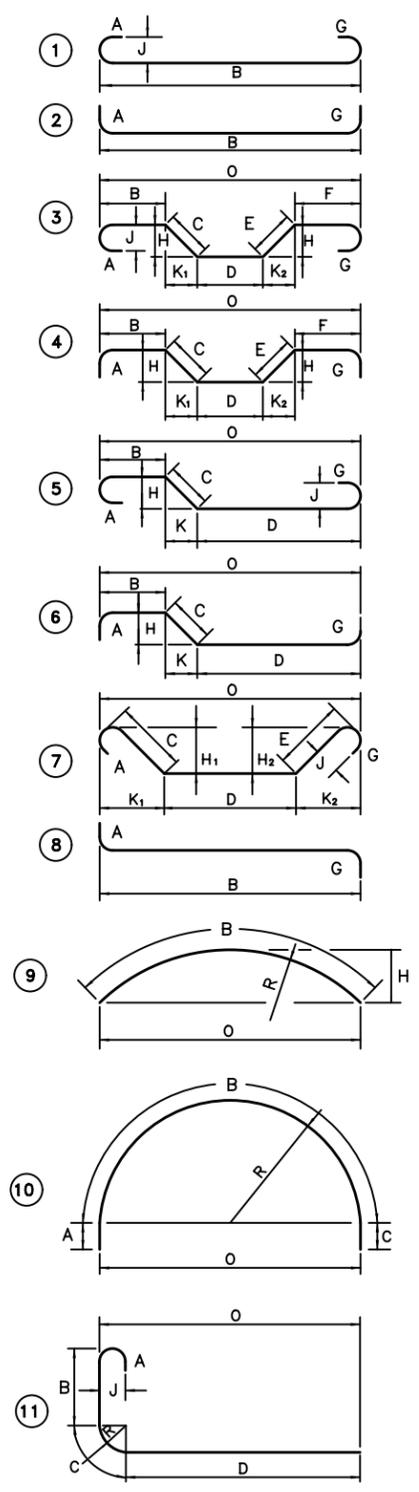

STEEL REINFORCEMENT NOTES:

- UNLESS OTHERWISE DESIGNATED, ALL BAR REINFORCEMENT FOR CONCRETE IN SIZES UP TO AND INCLUDING NO. 18 SHALL CONFORM TO THE REQUIREMENTS OF THE "SPECIFICATIONS FOR DEFORMED BILLET-STEEL BARS FOR CONCRETE REINFORCEMENT", ASTM A615-06a. ALL BARS SHALL BE GRADE 60, UNLESS OTHERWISE DESIGNATED.
- FOR TYPICAL BENDING DETAILS, RECOMMENDED P.I.N. DIAMETER "D" OF BENDS HOOKS AND OTHER STANDARD PRACTICES SEE ACI-318-05 & THE CONCRETE REINFORCING STEEL INSTITUTE (CRSI) "MANUAL OF STANDARD PRACTICES" (MSP).
- BARS WHICH REQUIRE MORE ACCURATE BENDING THAN STANDARD PRACTICES SHOULD HAVE LIMITS INDICATED ON THE BARLIST.
- ALL DIMENSIONS ARE OUT TO OUT OF BAR EXCEPT "A" AND "G" ON STANDARD 180° AND 135° HOOKS.
- DIMENSIONS "A","G" AND "J" ARE STANDARD BENDING DIMENSIONS PER EACH SIZE OF BAR. REFER TO C.R.S.I. - M.S.P. FOR DETAILS.
- WHERE SLOPE DIFFERS FROM 45°, DIMENSIONS "H" AND "K" MUST BE SHOWN ON BARLIST.
- ▲ - INDICATES BARS TO CUT TO FIT IN THE FIELD.

STEEL REINFORCEMENT NOTES CONT.:

- FIELD CUT ENDS OF REINFORCING STEEL SHALL BE REPAIRED AS PER SUBSECTION 556-3 OF THE N.Y.S. STANDARD SPECIFICATIONS. THE COST FOR THIS WORK SHALL BE INCLUDED IN THE PRICE BID FOR ITEM 556.0202.
- ITEM FOR REINFORCING STEEL IS AS FOLLOWS:
556.0202 - EPOXY-COATED BAR REINFORCEMENT FOR STRUCTURES.
- BAR MARK PROCEDURE IS AS FOLLOWS:
5BE03
 — SEQUENTIAL BAR NUMBER.
 — INDICATES BAR COATING (E=EPOXY-COATED)
 — INDICATES STRUCTURE TYPE AND/OR LOCATION (B=BEGIN ABT, E=END ABT, H=HEADWALL)
 — INDICATES BAR SIZE (IE. 5,6,7,ETC.)
- BAR MARKS SHOULD NORMALLY INCREASE IN SEQUENTIAL NUMBER AND SIZE FROM SMALLEST TO LARGEST AT EACH LOCATION.
- "*" - INDICATES BAR MARK IS OUT OF SEQUENCE.

STANDEE
(ISOMETRIC VIEW)

STANDEE
(ISOMETRIC VIEW)

AFFIX SEAL: GREENMAN - PEDERSEN, INC
 ON: APRIL 15, 2021

ALTERED BY:
 ON:



AS-BUILT REVISIONS DESCRIPTION OF ALTERATIONS:	VETERAN'S ROAD CULVERT REPLACEMENT	PIN 1761.09	BRIDGES	CULVERTS	ALL DIMENSIONS IN ft UNLESS OTHERWISE NOTED	CONTRACT NUMBER D036296
	OVER FIVE MILE CREEK				BAR BENDS	DRAWING NO. ST-30
	TOWN OF TICONDEROGA					SHEET NO. 42
	COUNTY: ESSEX	REGION: 1				

IT IS A VIOLATION OF LAW FOR ANY PERSON, UNLESS THEY ARE ACTING UNDER THE DIRECTION OF A LICENSED PROFESSIONAL ENGINEER, ARCHITECT, LANDSCAPE ARCHITECT, OR LAND SURVEYOR, TO ALTER AN ITEM IN ANY WAY. IF AN ITEM BEARING THE STAMP OF A LICENSED PROFESSIONAL IS ALTERED, THE ALTERING ENGINEER, ARCHITECT, LANDSCAPE ARCHITECT, OR LAND SURVEYOR SHALL STAMP THE DOCUMENT AND INCLUDE THE NOTATION "ALTERED BY" FOLLOWED BY THEIR SIGNATURE, THE DATE OF SUCH ALTERATION, AND A SPECIFIC DESCRIPTION OF THE ALTERATION.



MARK	NO.	SIZE	LENGTH	TYPE	WEIGHT	A	B	C	D	E	F	G	H/H1	H2	J	K/K1	K2	L	O	R	REMARKS
BEGIN ABUTMENT FOOTING (STAGE 1) - PLACEMENT 1																					
5BE01	8	5	2'-6"	STR	20.9																
5BE02	10	5	12'-0"	STR	125.2																
5BE03	42	5	8'-4"	2	365.1	10"	7'-6"					0"									
5BE04	9	5	15'-2"	STR	142.4																
5BE05	9	5	4'-0"	STR	37.5																WITH MECHANICAL CONNECTOR
5BE06	26	5	8'-6"	STR	230.5																
5BE07	8	5	3'-4"	N8	27.8		3"	5"	2'-0"	5"	3"									2'-6"	
5BE08	10	5	12'-10"	N8	133.9		3"	5"	2'-0"	5"	9'-9"									12'-0"	
TOTAL FOR PLACEMENT 1:					1,084	LBS.															

MARK	NO.	SIZE	LENGTH	TYPE	WEIGHT	A	B	C	D	E	F	G	H/H1	H2	J	K/K1	K2	L	O	R	REMARKS
END ABUTMENT FOOTING (STAGE 1) - PLACEMENT 2																					
5EE01	8	5	2'-6"	STR	20.9																
5EE02	10	5	12'-0"	STR	125.2																
5EE03	42	5	8'-4"	2	365.1	10"	7'-6"					0"									
5EE04	9	5	15'-2"	STR	142.4																
5EE05	9	5	4'-0"	STR	37.5																WITH MECHANICAL CONNECTOR
5EE06	26	5	8'-6"	STR	230.5																
5EE07	8	5	3'-4"	N8	27.8		3"	5"	2'-0"	5"	3"									2'-6"	
5EE08	10	5	12'-10"	N8	133.9		3"	5"	2'-0"	5"	9'-9"									12'-0"	
TOTAL FOR PLACEMENT 2:					1,084	LBS.															

MARK	NO.	SIZE	LENGTH	TYPE	WEIGHT	A	B	C	D	E	F	G	H/H1	H2	J	K/K1	K2	L	O	R	REMARKS
BEGIN RIGHT WINGWALL - PLACEMENT 3																					
5BE09	42	5	12'-3"	STR	536.6																
5BE10	18	5	9'-8"	STR	181.5																
5BE11	12	5	12'-9"	STR	159.6																
5BE12	21	5	7'-4"	17	160.6		3'-0"	1'-4"	3'-0"												
TOTAL FOR PLACEMENT 3:					1,039	LBS.															

MARK	NO.	SIZE	LENGTH	TYPE	WEIGHT	A	B	C	D	E	F	G	H/H1	H2	J	K/K1	K2	L	O	R	REMARKS
END RIGHT WINGWALL - PLACEMENT 4																					
5EE09	42	5	11'-10"	STR	518.4																
5EE10	18	5	9'-8"	STR	181.5																
5EE11	12	5	12'-9"	STR	159.6																
5EE12	21	5	7'-4"	17	160.6		3'-0"	1'-4"	3'-0"												
TOTAL FOR PLACEMENT 4:					1,021	LBS.															

MARK	NO.	SIZE	LENGTH	TYPE	WEIGHT	A	B	C	D	E	F	G	H/H1	H2	J	K/K1	K2	L	O	R	REMARKS
RIGHT HEADWALL - PLACEMENT 5																					
5HE01	12	5	16'-8"	STR	208.6																
6HE02	36	6	VARIES	17	281.6		10"	VARIES	0"												THREADED INSERT INTO MECHANICAL CONNECTOR MAX. "C" LENGTH = 4'-6", MIN. "C" LENGTH = 4'-3" (SEE NOTE 2)
TOTAL FOR PLACEMENT 5:					491	LBS.															

- NOTES:**
- ALL REINFORCEMENT, UNLESS OTHERWISE NOTED, SHALL BE EPOXY-COATED AND PAID UNDER ITEM 556.0202.
 - THE THREADED INSERTS (6HE02) ARE SIZED ASSUMING A 12" TOP SLAB ON THE PRECAST UNITS. THE REBAR LENGTH IS TO BE MODIFIED TO ACCOUNT FOR THE ACTUAL TOP SLAB DEPTH IN ACCORDANCE WITH THE CONTRACTOR'S APPROVED SHOP DRAWINGS.

AFFIX SEAL: GREENMAN - PEDERSEN, INC
 ON: APRIL 15, 2021

ALTERED BY:
 ON:



AS-BUILT REVISIONS DESCRIPTION OF ALTERATIONS:	VETERAN'S ROAD CULVERT REPLACEMENT	PIN 1761.09	BRIDGES	CULVERTS	ALL DIMENSIONS IN ft UNLESS OTHERWISE NOTED	CONTRACT NUMBER D036296	
	OVER FIVE MILE CREEK						
	TOWN OF TICONDEROGA						
COUNTY: ESSEX	REGION: 1	BAR LIST (1 OF 2)		DRAWING NO. ST-31 SHEET NO. 43			
IT IS A VIOLATION OF LAW FOR ANY PERSON, UNLESS THEY ARE ACTING UNDER THE DIRECTION OF A LICENSED PROFESSIONAL ENGINEER, ARCHITECT, LANDSCAPE ARCHITECT, OR LAND SURVEYOR, TO ALTER AN ITEM IN ANY WAY. IF AN ITEM BEARING THE STAMP OF A LICENSED PROFESSIONAL IS ALTERED, THE ALTERING ENGINEER, ARCHITECT, LANDSCAPE ARCHITECT, OR LAND SURVEYOR SHALL STAMP THE DOCUMENT AND INCLUDE THE NOTATION "ALTERED BY" FOLLOWED BY THEIR SIGNATURE, THE DATE OF SUCH ALTERATION, AND A SPECIFIC DESCRIPTION OF THE ALTERATION.							

MARK	NO.	SIZE	LENGTH	TYPE	WEIGHT	A	B	C	D	E	F	G	H/H1	H2	J	K/K1	K2	L	O	R	REMARKS
BEGIN ABUTMENT FOOTING (STAGE 2) - PLACEMENT 6																					
5BE13	7	5	2'-6"	STR	18.3																
5BE14	10	5	12'-0"	STR	125.2																
5BE15	42	5	8'-4"	2	365.1	10"	7'-6"					0"									
5BE16	9	5	14'-2"	STR	133.0																
5BE17	9	5	4'-0"	STR	37.5																THREADED INSERT INTO MECHANICAL CONNECTOR
5BE18	26	5	8'-6"	STR	230.5																
5BE19	7	5	3'-4"	N8	24.3		3"	5"	2'-0"	5"	3"									2'-6"	
5BE20	10	5	12'-10"	N8	133.9		3"	5"	2'-0"	5"	9'-9"									12'-0"	
TOTAL FOR PLACEMENT 6:					1,068	LBS.															

MARK	NO.	SIZE	LENGTH	TYPE	WEIGHT	A	B	C	D	E	F	G	H/H1	H2	J	K/K1	K2	L	O	R	REMARKS
END ABUTMENT FOOTING (STAGE 2) - PLACEMENT 7																					
5EE13	7	5	2'-6"	STR	18.3																
5EE14	10	5	12'-0"	STR	125.2																
5EE15	42	5	8'-4"	2	365.1	10"	7'-6"					0"									
5EE16	9	5	14'-2"	STR	133.0																
5EE17	9	5	4'-0"	STR	37.5																THREADED INSERT INTO MECHANICAL CONNECTOR
5EE18	26	5	8'-6"	STR	230.5																
5EE19	7	5	3'-4"	N8	24.3		3"	5"	2'-0"	5"	3"									2'-6"	
5EE20	10	5	12'-10"	N8	133.9		3"	5"	2'-0"	5"	9'-9"									12'-0"	
TOTAL FOR PLACEMENT 7:					1,068	LBS.															


MARK	NO.	SIZE	LENGTH	TYPE	WEIGHT	A	B	C	D	E	F	G	H/H1	H2	J	K/K1	K2	L	O	R	REMARKS
BEGIN LEFT WINGWALL - PLACEMENT 8																					
5BE21	42	5	12'-5"	STR	543.9																
5BE22	18	5	9'-8"	STR	181.5																
5BE23	12	5	12'-9"	STR	159.6																
5BE24	21	5	7'-4"	17	160.6		3'-0"	1'-4"	3'-0"												
TOTAL FOR PLACEMENT 8:					1,046	LBS.															

MARK	NO.	SIZE	LENGTH	TYPE	WEIGHT	A	B	C	D	E	F	G	H/H1	H2	J	K/K1	K2	L	O	R	REMARKS
END LEFT WINGWALL - PLACEMENT 9																					
5EE21	42	5	12'-3"	STR	536.6																
5EE22	18	5	9'-8"	STR	181.5																
5EE23	12	5	12'-9"	STR	159.6																
5EE24	21	5	7'-4"	17	160.6		3'-0"	1'-4"	3'-0"												
TOTAL FOR PLACEMENT 9:					1,039	LBS.															

MARK	NO.	SIZE	LENGTH	TYPE	WEIGHT	A	B	C	D	E	F	G	H/H1	H2	J	K/K1	K2	L	O	R	REMARKS
LEFT HEADWALL - PLACEMENT 10																					
5HE03	12	5	16'-8"	STR	208.6																
6HE04	36	6	VARIES	17	295.1		10"	VARIES	0"												THREADED INSERT INTO MECHANICAL CONNECTOR MAX. "C" LENGTH = 4'-8", MIN. "C" LENGTH = 4'-7" (SEE NOTE 2)
TOTAL FOR PLACEMENT 10:					504	LBS.															

- NOTES:**
- ALL REINFORCEMENT, UNLESS OTHERWISE NOTED, SHALL BE EPOXY-COATED AND PAID UNDER ITEM 556.0202.
 - THE THREADED INSERTS (6HE04) ARE SIZED ASSUMING A 12" TOP SLAB ON THE PRECAST UNITS. THE REBAR LENGTH IS TO BE MODIFIED TO ACCOUNT FOR THE ACTUAL TOP SLAB DEPTH IN ACCORDANCE WITH THE CONTRACTOR'S APPROVED SHOP DRAWINGS.

AFFIX SEAL: GREENMAN - PEDERSEN, INC
 ON: APRIL 15, 2021
 ALTERED BY:
 ON:

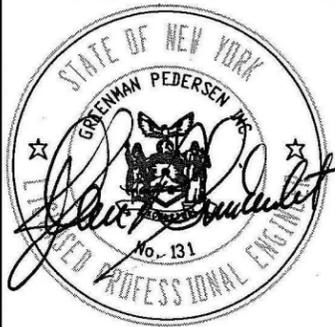

AS-BUILT REVISIONS DESCRIPTION OF ALTERATIONS:	VETERAN'S ROAD CULVERT REPLACEMENT	PIN 1761.09	BRIDGES	CULVERTS	ALL DIMENSIONS IN ft UNLESS OTHERWISE NOTED	CONTRACT NUMBER D036296
	OVER FIVE MILE CREEK					
	TOWN OF TICONDEROGA					
COUNTY: ESSEX	REGION: 1	BAR LIST (2 OF 2)		DRAWING NO. ST-32 SHEET NO. 44		
IT IS A VIOLATION OF LAW FOR ANY PERSON, UNLESS THEY ARE ACTING UNDER THE DIRECTION OF A LICENSED PROFESSIONAL ENGINEER, ARCHITECT, LANDSCAPE ARCHITECT, OR LAND SURVEYOR, TO ALTER AN ITEM IN ANY WAY. IF AN ITEM BEARING THE STAMP OF A LICENSED PROFESSIONAL IS ALTERED, THE ALTERING ENGINEER, ARCHITECT, LANDSCAPE ARCHITECT, OR LAND SURVEYOR SHALL STAMP THE DOCUMENT AND INCLUDE THE NOTATION "ALTERED BY" FOLLOWED BY THEIR SIGNATURE, THE DATE OF SUCH ALTERATION, AND A SPECIFIC DESCRIPTION OF THE ALTERATION.						

AFFIX SEAL: GREENMAN - PEDERSEN, INC
 ON: APRIL 15, 2021

ALTERED BY:
 ON:



AS-BUILT REVISIONS
 DESCRIPTION OF ALTERATIONS:

VETERAN'S ROAD CULVERT REPLACEMENT
 OVER FIVE MILE CREEK
 TOWN OF TICONDEROGA
 COUNTY: ESSEX REGION: 1

PIN 1761.09
 BRIDGES
 CULVERTS

ALL DIMENSIONS IN ft UNLESS OTHERWISE NOTED
 ESTIMATE OF QUANTITIES

CONTRACT NUMBER
 D036296
 DRAWING NO. EQQ-1
 SHEET NO. 45

IT IS A VIOLATION OF LAW FOR ANY PERSON, UNLESS THEY ARE ACTING UNDER THE DIRECTION OF A LICENSED PROFESSIONAL ENGINEER, ARCHITECT, LANDSCAPE ARCHITECT, OR LAND SURVEYOR, TO ALTER AN ITEM IN ANY WAY. IF AN ITEM BEARING THE STAMP OF A LICENSED PROFESSIONAL IS ALTERED, THE ALTERING ENGINEER, ARCHITECT, LANDSCAPE ARCHITECT, OR LAND SURVEYOR SHALL STAMP THE DOCUMENT AND INCLUDE THE NOTATION "ALTERED BY" FOLLOWED BY THEIR SIGNATURE, THE DATE OF SUCH ALTERATION, AND A SPECIFIC DESCRIPTION OF THE ALTERATION.



ESTIMATE OF QUANTITIES				
ITEM NO.	DESCRIPTION	UNIT	ESTIMATE	FINAL
202.120001	REMOVING EXISTING SUPERSTRUCTURES	LS	1	
202.19	REMOVAL OF SUBSTRUCTURES	CY	110	
203.03	EMBANKMENT IN PLACE	CY	420	
203.07	SELECT GRANULAR FILL	CY	25	
203.21	SELECT STRUCTURAL FILL	CY	410	
203.25	SAND BACKFILL	CY	15	
206.01	STRUCTURE EXCAVATION	CY	870	
206.0201	TRENCH AND CULVERT EXCAVATION	CY	10	
207.20	GEOTEXTILE BEDDING	SY	90	
207.26	PREFABRICATED COMPOSITE STRUCTURAL DRAIN	SY	90	
209.13	SILT FENCE - TEMPORARY	LF	300	
304.12	SUBBASE COURSE, TYPE 2	CY	120	
402.128304	12.5 F3 TOP COURSE HMA, 80 SERIES COMPACTION	TON	54	
402.198904	19 F9 BINDER COURSE HMA, 80 SERIES COMPACTION	TON	30	
402.378904	37.5 F9 BASE COURSE HMA, 80 SERIES COMPACTION	TON	44	
407.0103	STRAIGHT TACK COAT	GAL	37	
490.30	MISCELLANEOUS COLD MILLING OF BITUMINOUS CONCRETE	SY	385	
552.2001	HOLES IN EARTH FOR SOLDIER PILE AND LAGGING WALL	LF	105	
552.2101	ROCK SOCKETS FOR SOLDIER PILE AND LAGGING WALL	LF	40	
552.2201	SOLDIER PILES FOR SOLDIER PILE AND LAGGING WALL	LF	140	
552.230201	UNTREATED WOOD LAGGING FOR SOLDIER PILE AND LAGGING WALL	SF	1,040	
553.020001	COFFERDAM (TYPE 2)	EA	2	
554.3001	GEOSYNTHETIC REINFORCED SOIL SYSTEM WALL - WELDED WIRE FORM	SF	140	
555.08	FOOTING CONCRETE, CLASS HP	CY	63	
555.09	CONCRETE FOR STRUCTURES, CLASS HP	CY	45	
556.0202	EPOXY-COATED BAR REINFORCEMENT FOR STRUCTURES	LB	9,500	
562.0101	REINFORCED CONCRETE SPAN UNITS	SY	60	
568.54	STEEL BRIDGE RAILING (THREE RAIL)	LF	78	
568.70	TRANSITION BRIDGE RAILING	LF	128	
586.0201	DRILLING AND GROUTING BOLTS OR REINFORCEMENT BARS	EA	48	
595.50000018	SHEET-APPLIED WATERPROOFING MEMBRANE	SF	244	
606.10	BOX BEAM GUIDE RAILING	LF	66	
606.100002	BOX BEAM GUIDE RAILING (SHOP BENT)	LF	27	
606.120101	BOX BEAM END PIECE	EA	1	
606.120201	BOX BEAM GUIDE RAILING END ASSEMBLY, TYPE IIA	EA	3	
606.73	REMOVING AND DISPOSING BOX BEAM GUIDE RAILING	LF	355	
610.1402	TOPSOIL - ROADSIDE	CY	10	
610.1601	TURF ESTABLISHMENT - ROADSIDE	SY	65	
619.01	BASIC WORK ZONE TRAFFIC CONTROL	LS	1	
619.1715	TEMPORARY POSITIVE BARRIER - CATEGORY 5 (PINNING PROHIBITED)	LF	500	
620.04	STONE FILLING (MEDIUM)	CY	80	
625.01	SURVEY OPERATIONS	LS	1	
627.50140008	CUTTING PAVEMENT	LF	60	
637.11	ENGINEER'S FIELD OFFICE - TYPE 1	MNTH	4	
637.34	OFFICE TECHNOLOGY AND SUPPLIES	DC	1,000	
646.23	LARGE SNOWPLOWING DELINEATOR	EA	13	
646.32	STEEL POST, 2.0 LB/FT	EA	9	
660.21160008	FURNISH AND INSTALL STEEL CASING 16 NPS (OUTSIDE DIAMETER)	LF	50	
663.0408	PLASTIC WATER PIPE, 8"	LF	50	
663.1808	BOLTED SLEEVE TYPE COUPLING, 8"	EA	2	
663.240803	INSULATION FOR BURIED WATER PIPE (8" WITH 3 IN THICK INSULATION)	LF	50	
663.29010407	TEMPORARY WATER MAIN - 04 NPS	LF	50	
663.4104	REMOVE AND DISPOSE OF EXISTING WATER MAIN, 4"	LF	50	
697.03	FIELD CHANGE PAYMENT	DC	24,000	
698.04	ASPHALT PRICE ADJUSTMENT	DC	100	
698.05	FUEL PRICE ADJUSTMENT	DC	100	
699.040001	MOBILIZATION	LS	1	